

EROSION CONTROL NOTES:

SEE SWPPP ON SHEETS SW1.0-SW1.5


REMOVAL NOTES:

- SEE STORM WATER POLLUTION PREVENTION PLAN (SWPPP) PLAN FOR CONSTRUCTION STORM WATER MANAGEMENT PLAN.
- REMOVAL OF MATERIALS NOTED ON THE DRAWINGS SHALL BE IN ACCORDANCE WITH MNDOT, STATE AND LOCAL REGULATIONS.
- 3. REMOVAL OF PRIVATE UTILITIES SHALL BE COORDINATED WITH UTILITY OWNER PRIOR TO CONSTRUCTION ACTIVITIES.
- 4. EXISTING PAVEMENTS SHALL BE SAWCUT IN LOCATIONS AS SHOWN ON THE DRAWINGS OR THE NEAREST JOINT FOR PROPOSED PAVEMENT CONNECTIONS.
- REMOVED MATERIALS SHALL BE DISPOSED OF TO A LEGAL OFF-SITE LOCATION AND IN ACCORDANCE WITH STATE AND LOCAL REGULATIONS.
- ABANDON, REMOVAL, CONNECTION, AND PROTECTION NOTES SHOWN ON THE DRAWINGS ARE APPROXIMATE. COORDINATE WITH PROPOSED PLANS.
- 7. EXISTING ON-SITE FEATURES NOT NOTED FOR REMOVAL SHALL BE PROTECTED THROUGHOUT THE DURATION OF THE CONTRACT.
- PROPERTY LINES SHALL BE CONSIDERED GENERAL CONSTRUCTION LIMITS UNLESS OTHERWISE NOTED ON THE DRAWINGS. WORK WITHIN THE GENERAL CONSTRUCTION LIMITS SHALL INCLUDE STAGING, DEMOLITION AND CLEAN-UP OPERATIONS AS WELL AS CONSTRUCTION SHOWN ON THE DRAWINGS.
- MINOR WORK OUTSIDE OF THE GENERAL CONSTRUCTION LIMITS SHALL BE ALLOWED AS SHOWN ON THE PLAN AND PER CITY REQUIREMENTS.
- 10. DAMAGE BEYOND THE PROPERTY LIMITS CAUSED BY CONSTRUCTION ACTIVITY SHALL BE REPAIRED IN A MANNER APPROVED BY THE ENGINEER/LANDSCAPE ARCHITECT OR IN ACCORDANCE WITH THE CITY.
- 11. PROPOSED WORK (BUILDING AND CIVIL) SHALL NOT DISTURB EXISTING UTILITIES UNLESS OTHERWISE SHOWN ON THE DRAWINGS AND APPROVED BY THE CITY PRIOR TO CONSTRUCTION.
- 12. SITE SECURITY MAY BE NECESSARY AND PROVIDED IN A MANNER TO PROHIBIT VANDALISM, AND THEFT, DURING AND AFTER NORMAL WORK HOURS, THROUGHOUT THE DURATION OF THE CONTRACT. SECURITY MATERIALS SHALL BE IN ACCORDANCE WITH THE CITY.
- 13. VEHICULAR ACCESS TO THE SITE SHALL BE MAINTAINED FOR DELIVERY AND INSPECTION ACCESS DURING NORMAL OPERATING HOURS. AT NO POINT THROUGHOUT THE DURATION OF THE CONTRACT SHALL CIRCULATION OF ADJACENT STREETS BE BLOCKED WITHOUT APPROVAL BY THE CITY PRIOR TO CONSTRUCTION ACTIVITIES.
- 14. ALL TRAFFIC CONTROLS SHALL BE PROVIDED AND ESTABLISHED PER THE REQUIREMENTS OF THE MINNESOTA MANUAL ON UNIFORM TRAFFIC CONTROL DEVICES (MMUTCD) AND THE CITY. THIS SHALL INCLUDE, BUT NOT BE LIMITED TO, SIGNAGE, BARRICADES, FLASHERS, AND FLAGGERS AS NEEDED. ALL PUBLIC STREETS SHALL REMAIN OPEN TO TRAFFIC AT ALL TIMES. NO ROAD CLOSURES SHALL BE PERMITTED WITHOUT APPROVAL BY THE CITY.
- 15. SHORING FOR BUILDING EXCAVATION MAY BE USED AT THE DISCRETION OF THE CONTRACTOR AND AS APPROVED BY THE OWNERS REPRESENTATIVE AND THE CITY PRIOR TO CONSTRUCTION ACTIVITIES.
- 16. STAGING, DEMOLITION, AND CLEAN-UP AREAS SHALL BE WITHIN THE PROPERTY LIMITS AS SHOWN ON THE DRAWINGS AND MAINTAINED IN A MANNER AS REQUIRED BY THE CITY.

CITY OF APPLE VALLEY REMOVAL NOTES:

- REMOVAL OF THE EXISTING STRUCTURES, PAVEMENT, AND BASE SHALL BE DONE IN ACCORDANCE WITH LOCAL, STATE AND FEDERAL REGULATIONS; AND ALL THE REQUIRED PERMITS AND INSPECTIONS SHALL BE PERFORMED.
- NOTIFICATION IS REQUIRED 7 DAYS IN ADVANCE OF LANE OR STREET CLOSURES. 7-DAY ADVANCE WARNING SIGNAGE AND NOTICES TO AFFECTED BUSINESSES FOR THE CLOSURE SHALL BE PROVIDED BY THE CONTRACTOR.
- A TRAFFIC CONTROL PLAN SHALL BE SUBMITTED AND APPROVED FOR ALL LANE CLOSURES BY THE CONTRACTOR. FLAGMEN SHALL BE PROVIDED AS
- 4. AN OBSTRUCTION PERMIT SHALL BE APPLIED FOR AND APPROVED WITH DAKOTA COUNTY FOR DETOUR ROUTING PRIOR TO LANE OR STREET CLOSURES.
- 5. PUBLIC WORKS IS TO BE NOTIFIED PRIOR TO ANY REQUIRED WATER SHUTDOWN AND/OR CONNECTION.

REMOVALS LEGEND:

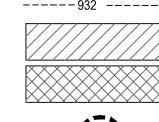


----932 ----- EX. 1' CONTOUR ELEVATION INTERVAL REMOVAL OF PAVEMENT AND ALL BASE MATERIAL, INCLUDING BIT., CONC., AND GRAVEL PVMTS. REMOVAL OF STRUCTURE INCLUDING ALL FOOTINGS AND FOUNDATIONS.



TREE PROTECTION

TREE REMOVAL - INCLUDING ROOTS AND STUMPS



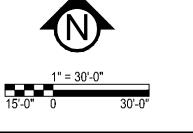

G R O 4931 W. 35TH ST. SUITE 200 ST. LOUIS PARK, MN 55416 CivilSiteGroup.com Matt Pavek Pat Sarve 763-213-3944 952-250-2003

I HEREBY CERTIFY THAT THIS PLAN, SPECIFICATION, OR REPORT WAS PREPARED BY ME OR UNDER MY DIRECT SUPERVISION AND THAT I AM A DULY LICENSED PROFESSIONAL ENGINEER UNDER THE LAWS OF THE STATE OF


DATE 04/11/16 LICENSE NO. 44263

ISSUE/SUBMITTAL SUMMARY DATE DESCRIPTION 04/11/16 CITY SUBMITTAL

REVISION SUMMARY


DATE DESCRIPTION

REMOVALS PLAN

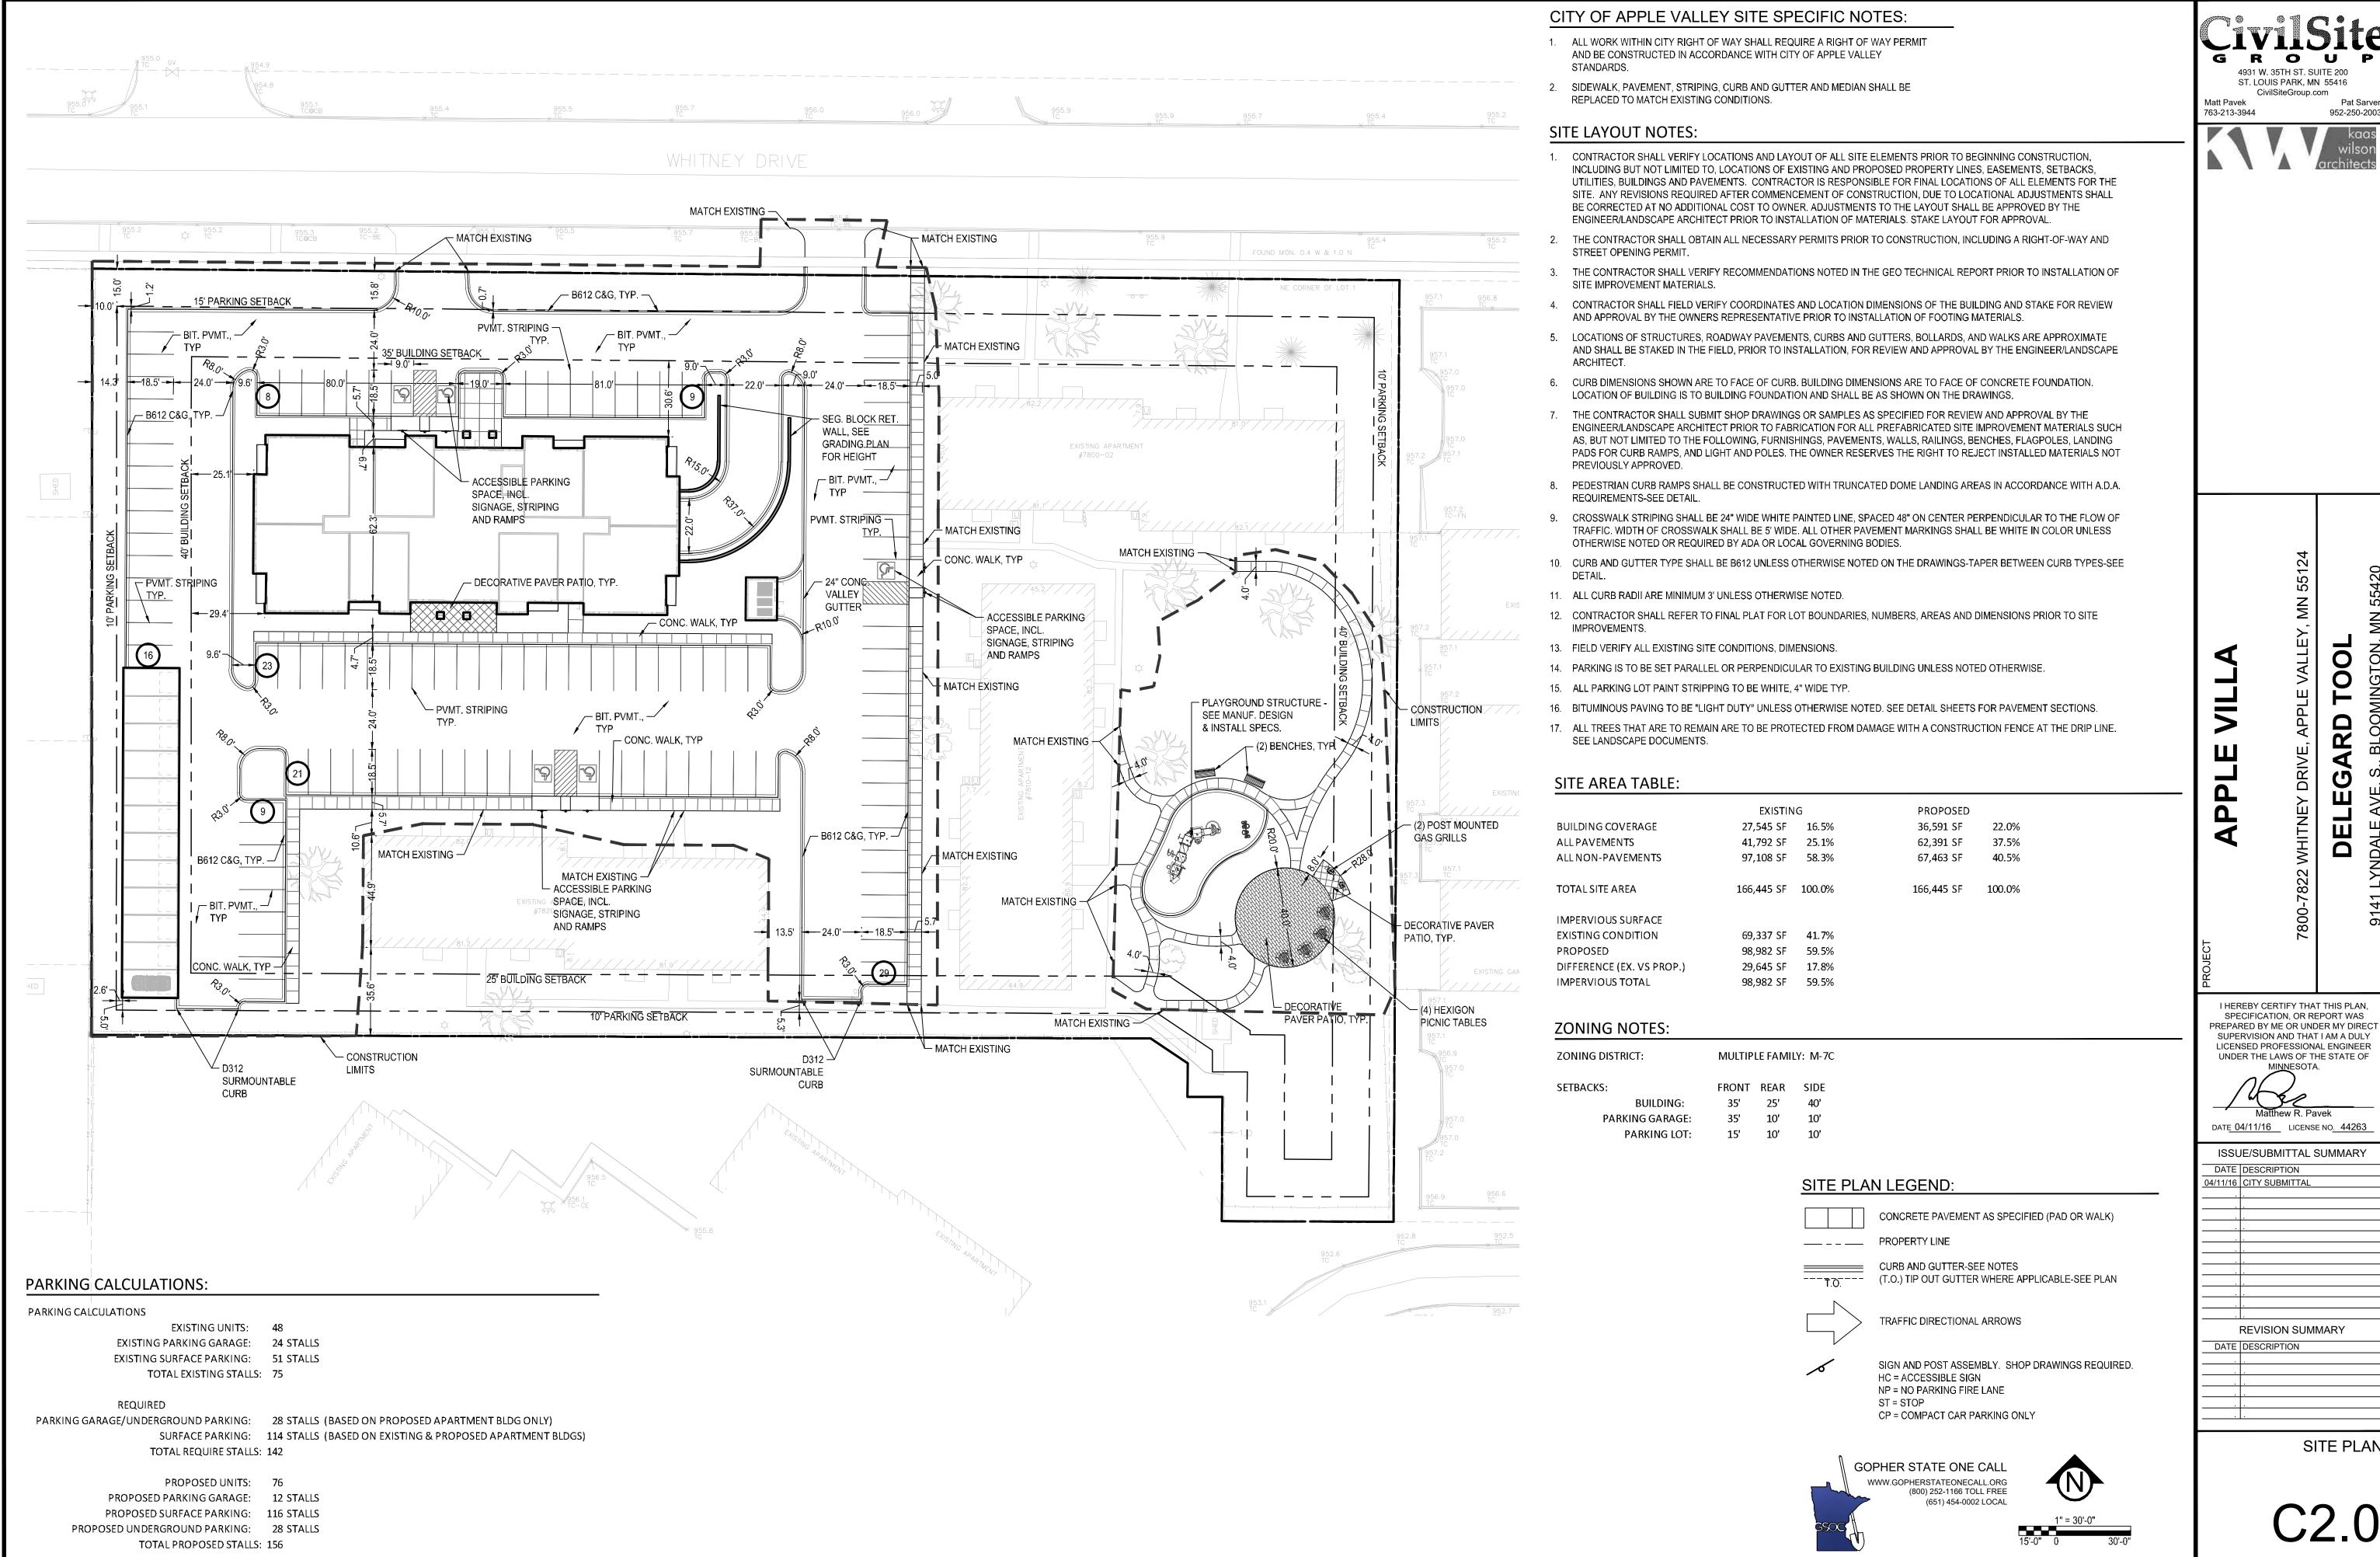

Pat Sarve

SITE PLAN

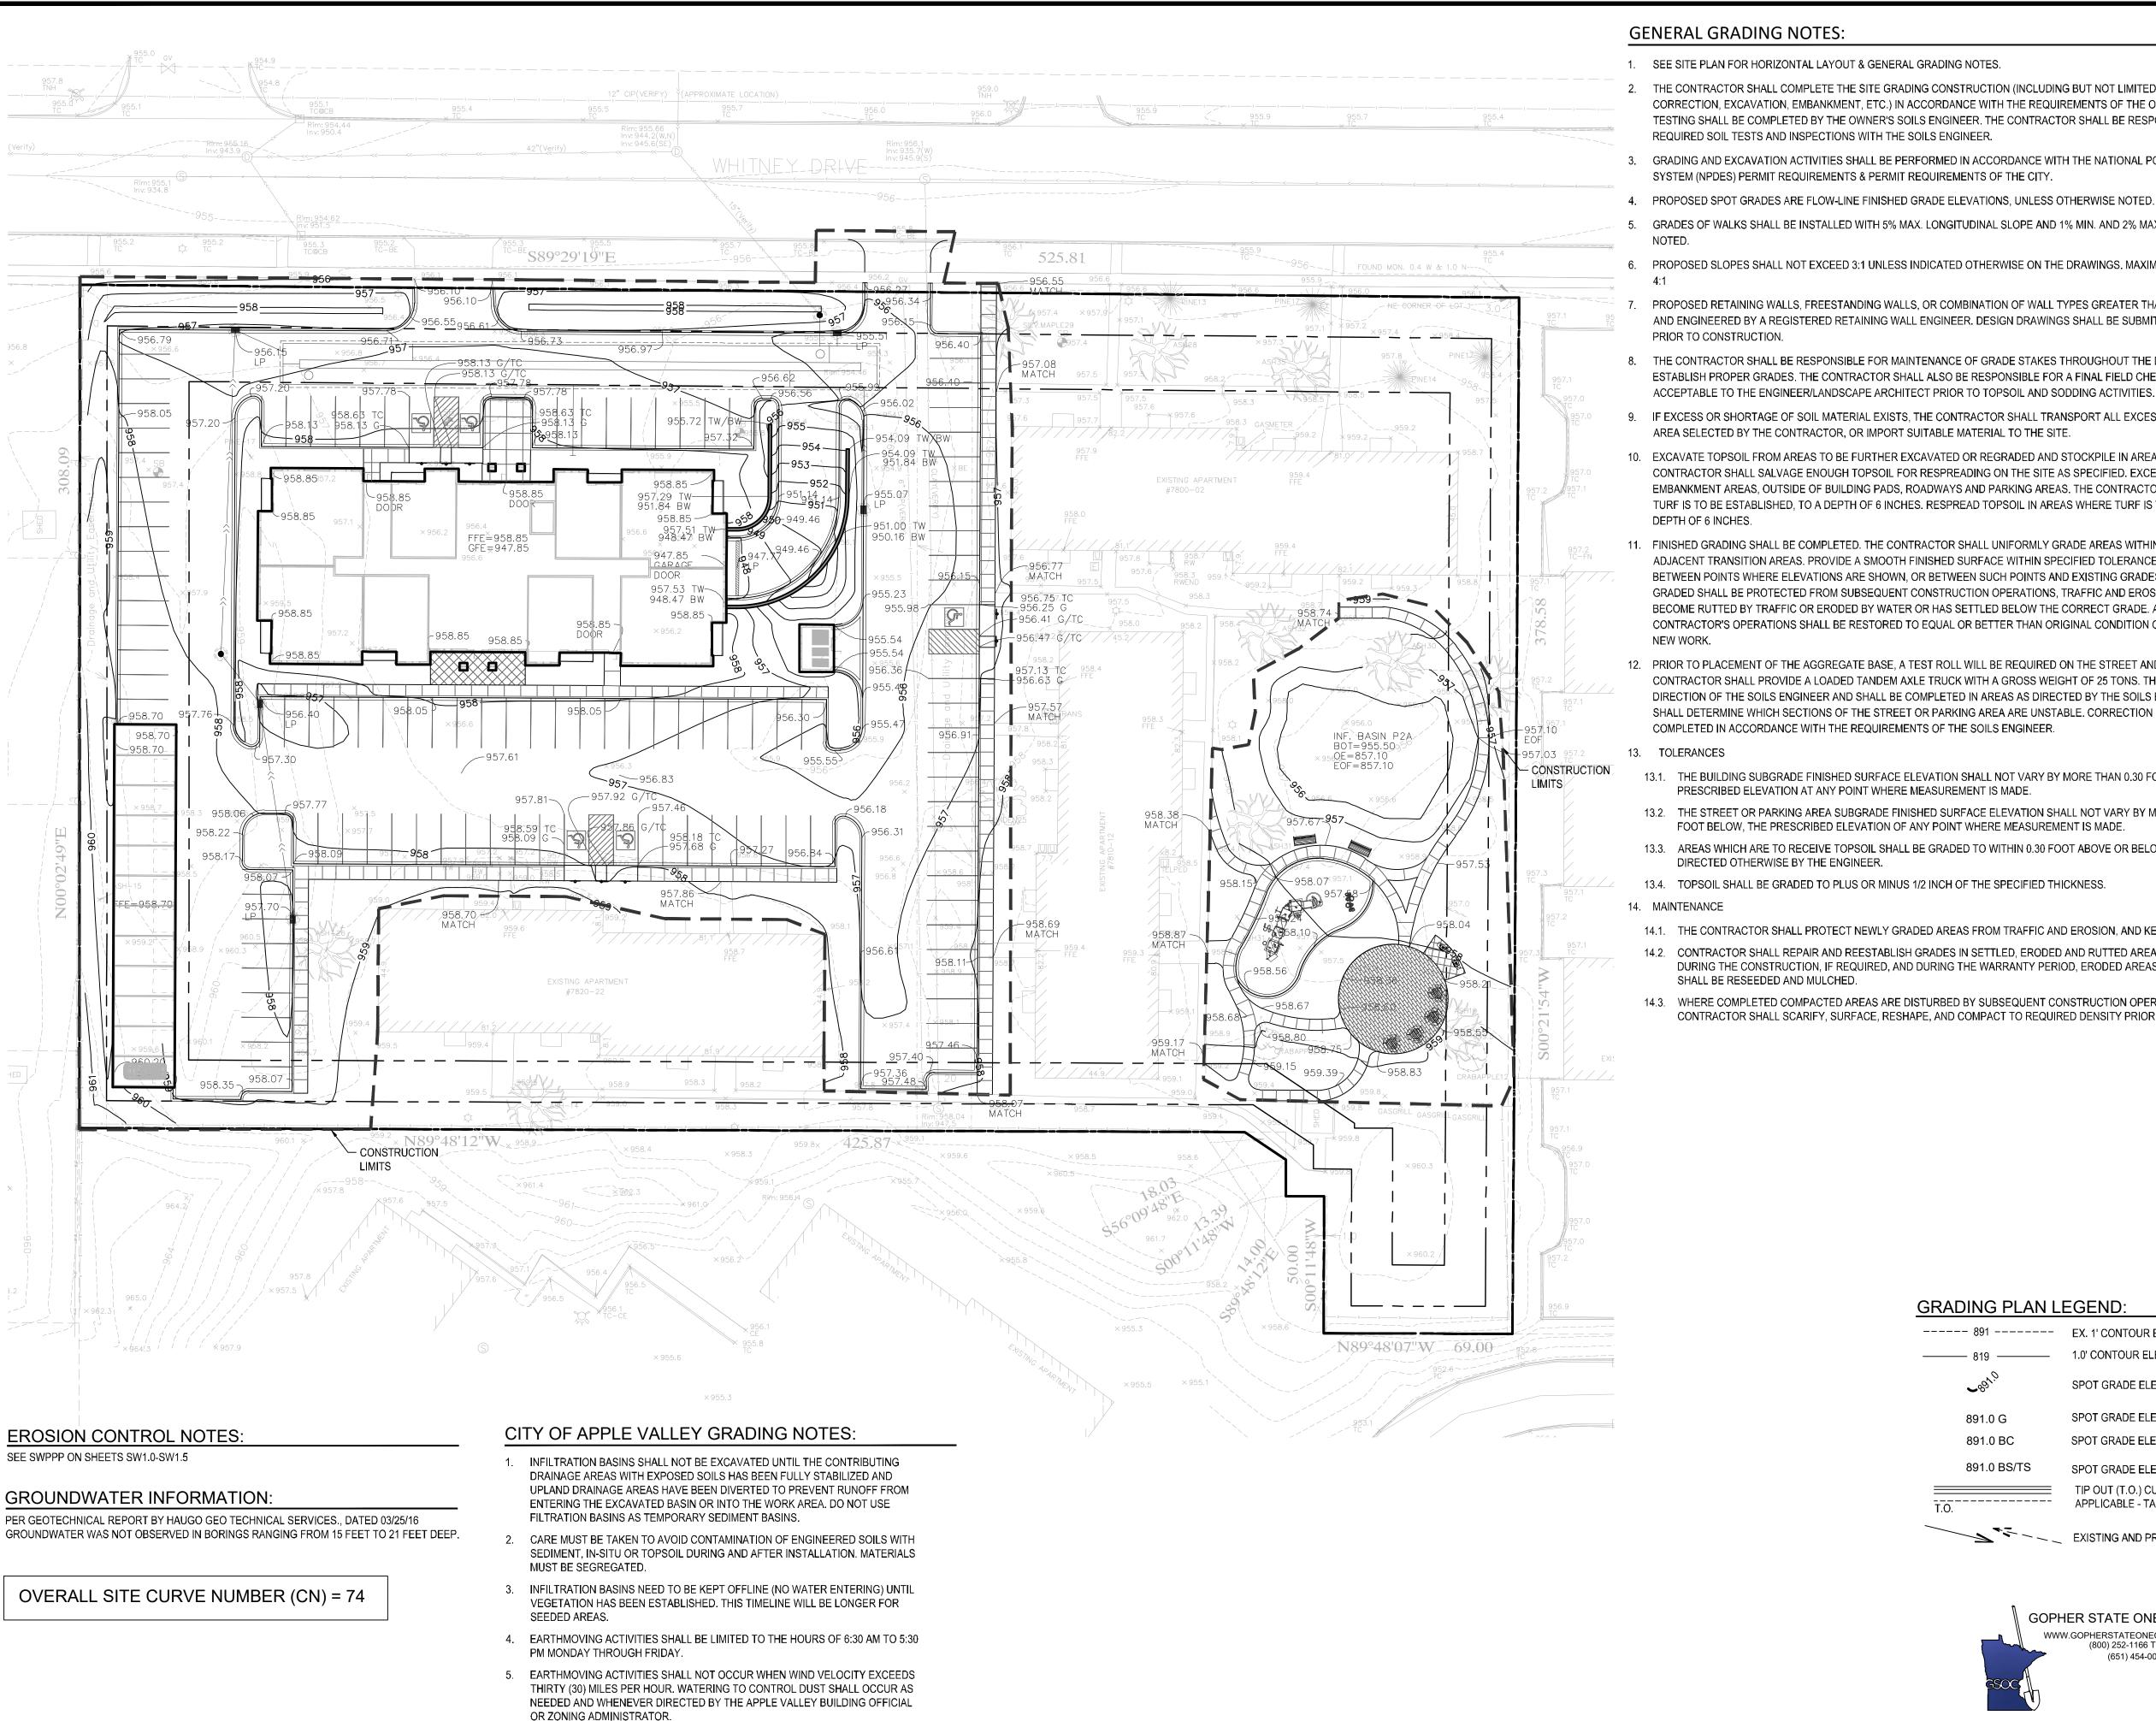

2. THE CONTRACTOR SHALL COMPLETE THE SITE GRADING CONSTRUCTION (INCLUDING BUT NOT LIMITED TO SITE PREPARATION, SOIL CORRECTION, EXCAVATION, EMBANKMENT, ETC.) IN ACCORDANCE WITH THE REQUIREMENTS OF THE OWNER'S SOILS ENGINEER. ALL SOIL TESTING SHALL BE COMPLETED BY THE OWNER'S SOILS ENGINEER. THE CONTRACTOR SHALL BE RESPONSIBLE FOR COORDINATING ALL

GRADING AND EXCAVATION ACTIVITIES SHALL BE PERFORMED IN ACCORDANCE WITH THE NATIONAL POLLUTION DISCHARGE ELIMINATION

- GRADES OF WALKS SHALL BE INSTALLED WITH 5% MAX. LONGITUDINAL SLOPE AND 1% MIN. AND 2% MAX. CROSS SLOPE, UNLESS OTHERWISE
- 6. PROPOSED SLOPES SHALL NOT EXCEED 3:1 UNLESS INDICATED OTHERWISE ON THE DRAWINGS. MAXIMUM SLOPES IN MAINTAINED AREAS IS
- PROPOSED RETAINING WALLS, FREESTANDING WALLS, OR COMBINATION OF WALL TYPES GREATER THAN 4' IN HEIGHT SHALL BE DESIGNED AND ENGINEERED BY A REGISTERED RETAINING WALL ENGINEER. DESIGN DRAWINGS SHALL BE SUBMITTED FOR REVIEW AND APPROVAL
- 8. THE CONTRACTOR SHALL BE RESPONSIBLE FOR MAINTENANCE OF GRADE STAKES THROUGHOUT THE DURATION OF CONSTRUCTION TO ESTABLISH PROPER GRADES. THE CONTRACTOR SHALL ALSO BE RESPONSIBLE FOR A FINAL FIELD CHECK OF FINISHED GRADES ACCEPTABLE TO THE ENGINEER/LANDSCAPE ARCHITECT PRIOR TO TOPSOIL AND SODDING ACTIVITIES.
- 9. IF EXCESS OR SHORTAGE OF SOIL MATERIAL EXISTS, THE CONTRACTOR SHALL TRANSPORT ALL EXCESS SOIL MATERIAL OFF THE SITE TO AN AREA SELECTED BY THE CONTRACTOR, OR IMPORT SUITABLE MATERIAL TO THE SITE.
- 10. EXCAVATE TOPSOIL FROM AREAS TO BE FURTHER EXCAVATED OR REGRADED AND STOCKPILE IN AREAS DESIGNATED ON THE SITE. THE CONTRACTOR SHALL SALVAGE ENOUGH TOPSOIL FOR RESPREADING ON THE SITE AS SPECIFIED. EXCESS TOPSOIL SHALL BE PLACED IN EMBANKMENT AREAS, OUTSIDE OF BUILDING PADS, ROADWAYS AND PARKING AREAS. THE CONTRACTOR SHALL SUBCUT CUT AREAS, WHERE TURF IS TO BE ESTABLISHED, TO A DEPTH OF 6 INCHES. RESPREAD TOPSOIL IN AREAS WHERE TURF IS TO BE ESTABLISHED TO A MINIMUM
- 11. FINISHED GRADING SHALL BE COMPLETED. THE CONTRACTOR SHALL UNIFORMLY GRADE AREAS WITHIN LIMITS OF GRADING, INCLUDING ADJACENT TRANSITION AREAS. PROVIDE A SMOOTH FINISHED SURFACE WITHIN SPECIFIED TOLERANCES, WITH UNIFORM LEVELS OR SLOPES BETWEEN POINTS WHERE ELEVATIONS ARE SHOWN, OR BETWEEN SUCH POINTS AND EXISTING GRADES. AREAS THAT HAVE BEEN FINISH GRADED SHALL BE PROTECTED FROM SUBSEQUENT CONSTRUCTION OPERATIONS, TRAFFIC AND EROSION. REPAIR ALL AREAS THAT HAVE BECOME RUTTED BY TRAFFIC OR ERODED BY WATER OR HAS SETTLED BELOW THE CORRECT GRADE. ALL AREAS DISTURBED BY THE CONTRACTOR'S OPERATIONS SHALL BE RESTORED TO EQUAL OR BETTER THAN ORIGINAL CONDITION OR TO THE REQUIREMENTS OF THE
- 12. PRIOR TO PLACEMENT OF THE AGGREGATE BASE, A TEST ROLL WILL BE REQUIRED ON THE STREET AND/OR PARKING AREA SUBGRADE. THE CONTRACTOR SHALL PROVIDE A LOADED TANDEM AXLE TRUCK WITH A GROSS WEIGHT OF 25 TONS. THE TEST ROLLING SHALL BE AT THE DIRECTION OF THE SOILS ENGINEER AND SHALL BE COMPLETED IN AREAS AS DIRECTED BY THE SOILS ENGINEER. THE SOILS ENGINEER SHALL DETERMINE WHICH SECTIONS OF THE STREET OR PARKING AREA ARE UNSTABLE. CORRECTION OF THE SUBGRADE SOILS SHALL BE
- 13.1. THE BUILDING SUBGRADE FINISHED SURFACE ELEVATION SHALL NOT VARY BY MORE THAN 0.30 FOOT ABOVE, OR 0.30 FOOT BELOW, THE
- 13.2. THE STREET OR PARKING AREA SUBGRADE FINISHED SURFACE ELEVATION SHALL NOT VARY BY MORE THAN 0.05 FOOT ABOVE, OR 0.10 FOOT BELOW, THE PRESCRIBED ELEVATION OF ANY POINT WHERE MEASUREMENT IS MADE
- 13.3. AREAS WHICH ARE TO RECEIVE TOPSOIL SHALL BE GRADED TO WITHIN 0.30 FOOT ABOVE OR BELOW THE REQUIRED ELEVATION, UNLESS
- 13.4. TOPSOIL SHALL BE GRADED TO PLUS OR MINUS 1/2 INCH OF THE SPECIFIED THICKNESS.
- 14.1. THE CONTRACTOR SHALL PROTECT NEWLY GRADED AREAS FROM TRAFFIC AND EROSION, AND KEEP AREA FREE OF TRASH AND DEBRIS.
- 14.2. CONTRACTOR SHALL REPAIR AND REESTABLISH GRADES IN SETTLED, ERODED AND RUTTED AREAS TO SPECIFIED TOLERANCES. DURING THE CONSTRUCTION, IF REQUIRED, AND DURING THE WARRANTY PERIOD, ERODED AREAS WHERE TURF IS TO BE ESTABLISHED
- 14.3. WHERE COMPLETED COMPACTED AREAS ARE DISTURBED BY SUBSEQUENT CONSTRUCTION OPERATIONS OR ADVERSE WEATHER, CONTRACTOR SHALL SCARIFY, SURFACE, RESHAPE, AND COMPACT TO REQUIRED DENSITY PRIOR TO FURTHER CONSTRUCTION.


SPOT GRADE ELEVATION BOTTOM OF STAIRS/TOP OF STAIRS

TIP OUT (T.O.) CURB AND GUTTER WHERE


GRA	DIN	GP	ΙΔΝ	ΙF	GEN	D·

----- 891 ----- EX. 1' CONTOUR ELEVATION INTERVAL 1.0' CONTOUR ELEVATION INTERVAL SPOT GRADE ELEVATION (FLOW LINE UNLESS OTHERWISE NOTED) SPOT GRADE ELEVATION GUTTER SPOT GRADE ELEVATION BACK OF CURB (TOP OF CURB)

APPLICABLE - TAPER GUTTERS TO DRAIN AS SHOWN

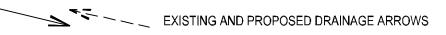



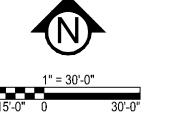

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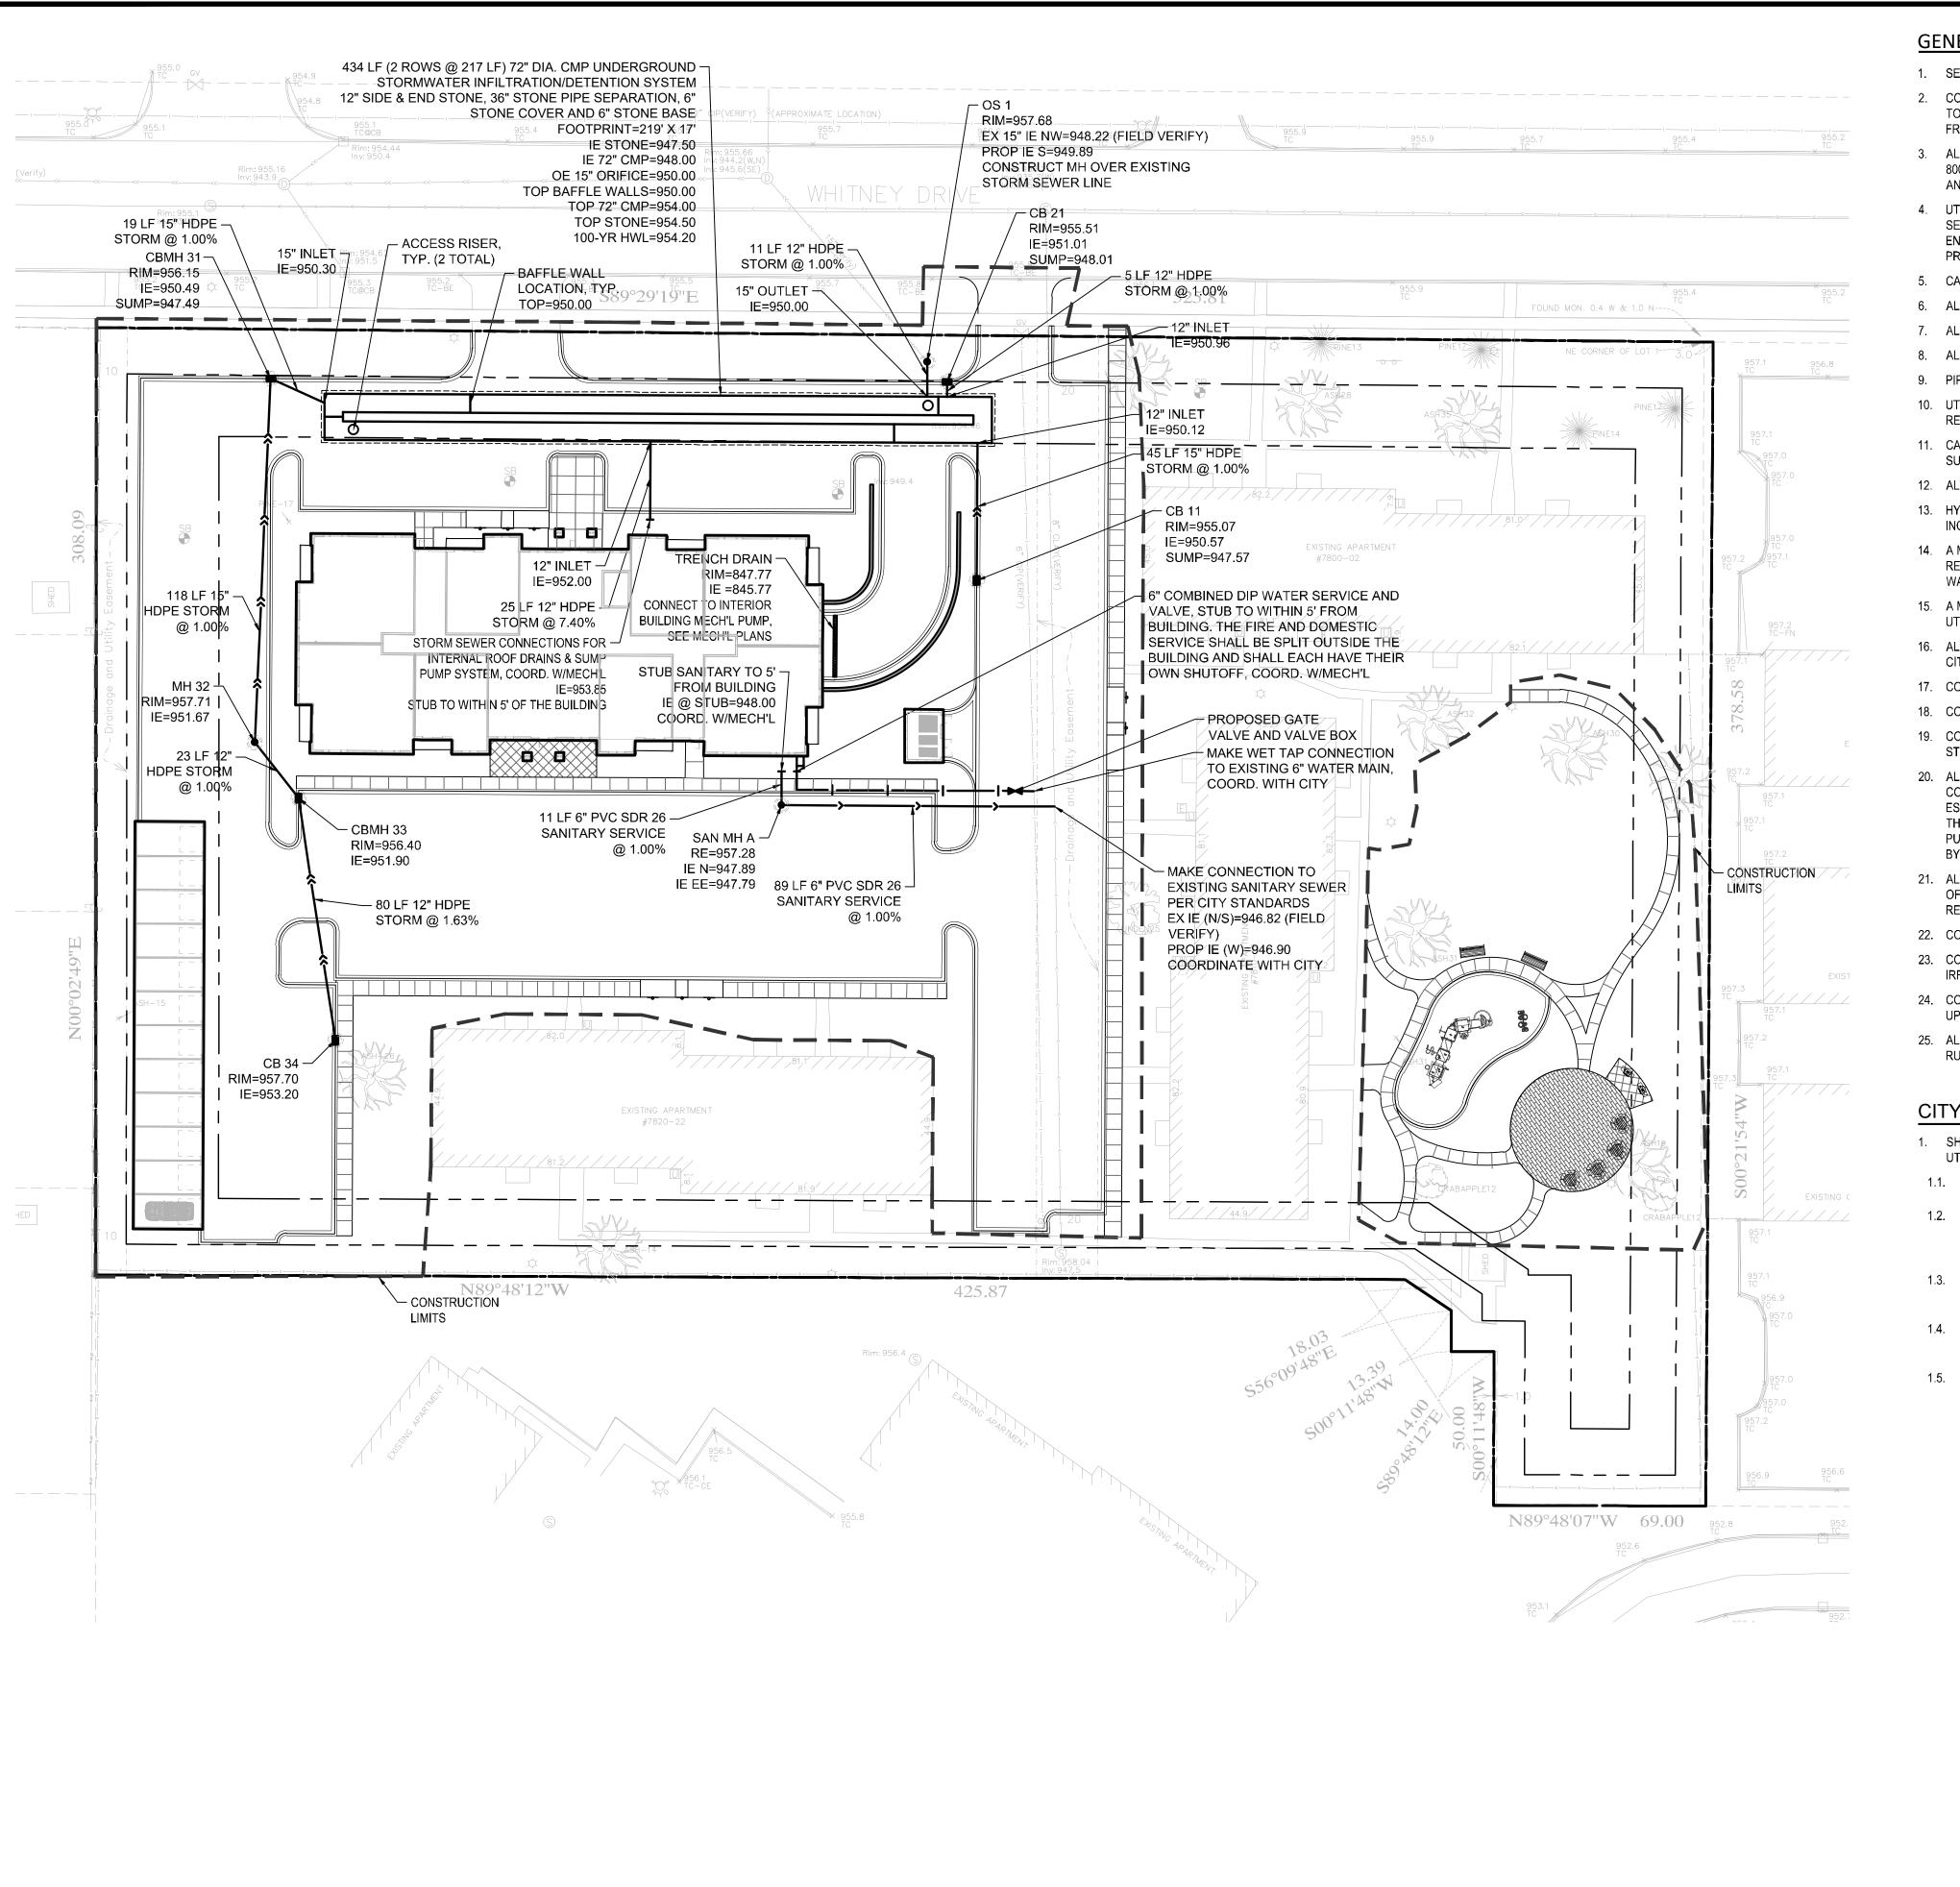
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GRADING PLAN



GENERAL UTILITY NOTES:

- 1. SEE SITE PLAN FOR HORIZONTAL DIMENSIONS AND LAYOUT.
- CONTRACTOR SHALL FIELD VERIFY LOCATION AND ELEVATION OF EXISTING UTILITIES AND TOPOGRAPHIC FEATURES PRIOR
 TO CONSTRUCTION. THE CONTRACTOR SHALL IMMEDIATELY NOTIFY THE ENGINEER OF DISCREPANCIES OR VARIATIONS
 FROM THE PLANS.
- 3. ALL EXISTING UTILITY LOCATIONS SHOWN ARE APPROXIMATE. CONTACT "GOPHER STATE ONE CALL" (651-454-0002 OR 800-252-1166) FOR UTILITY LOCATIONS, 48 HOURS PRIOR TO CONSTRUCTION. THE CONTRACTOR SHALL REPAIR OR REPLACE ANY UTILITIES THAT ARE DAMAGED DURING CONSTRUCTION AT NO COST TO THE OWNER.
- 4. UTILITY INSTALLATION SHALL CONFORM TO THE CURRENT EDITION OF "STANDARD SPECIFICATIONS FOR WATER MAIN AND SERVICE LINE INSTALLATION" AND "SANITARY SEWER AND STORM SEWER INSTALLATION" AS PREPARED BY THE CITY ENGINEERS ASSOCIATION OF MINNESOTA (CEAM), AND SHALL CONFORM WITH THE REQUIREMENTS OF THE CITY AND THE PROJECT SPECIFICATIONS.
- 5. CASTINGS SHALL BE SALVAGED FROM STRUCTURE REMOVALS AND RE-USED OR PLACED AT THE DIRECTION OF THE OWNER.
- 6. ALL WATER PIPE SHALL BE CLASS 52 DUCTILE IRON PIPE (DIP) UNLESS OTHERWISE NOTED.
- 7. ALL SANITARY SEWER SHALL BE SDR 26 POLYVINYL CHLORIDE (PVC) UNLESS OTHERWISE NOTED.
- 8. ALL STORM SEWER PIPE SHALL BE HDPE UNLESS OTHERWISE NOTED.
- 9. PIPE LENGTHS SHOWN ARE FROM CENTER TO CENTER OF STRUCTURE OR TO END OF FLARED END SECTION.
- 10. UTILTIES ON THE PLAN ARE SHOWN TO WITHIN 5' OF THE BUILDING FOOTPRINT. THE CONTRACTOR IS ULTIMATELY RESPONSIBLE FOR THE FINAL CONNECTION TO BUILDING LINES. COORDINATE WITH ARCHITECTURAL AND MECHANICAL PLANS.
- 11. CATCH BASINS AND MANHOLES IN PAVED AREAS SHALL BE SUMPED 0.04 FEET. ALL CATCH BASINS IN GUTTERS SHALL BE SUMPED 0.15 FEET PER DETAILS. RIM ELEVATIONS SHOWN ON THIS PLAN DO NOT REFLECT SUMPED ELEVATIONS.
- 12. ALL FIRE HYDRANTS SHALL BE LOCATED 5 FEET BEHIND BACK OF CURB UNLESS OTHERWISE NOTED.
- 13. HYDRANT TYPE, VALVE, AND CONNECTION SHALL BE IN ACCORDANCE WITH CITY REQUIREMENTS. HYDRANT EXTENSIONS ARE INCIDENTAL.
- 14. A MINIMUM OF 8 FEET OF COVER IS REQUIRED OVER ALL WATERMAIN, UNLESS OTHERWISE NOTED. EXTRA DEPTH MAY BE REQUIRED TO MAINTAIN A MINIMUM OF 18" VERTICAL SEPARATION TO SANITARY OR STORM SEWER LINES. EXTRA DEPTH WATERMAIN IS INCIDENTAL.
- 15. A MINIMUM OF 18 INCHES OF VERTICAL SEPARATION AND 10 FEET OF HORIZONTAL SEPARATION IS REQUIRED FOR ALL UTILITIES, UNLESS OTHERWISE NOTED.
- 16. ALL CONNECTIONS TO EXISTING UTILITIES SHALL BE IN ACCORDANCE WITH CITY STANDARDS AND COORDINATED WITH THE CITY PRIOR TO CONSTRUCTION.
- 17. CONNECTIONS TO EXISTING STRUCUTRES SHALL BE CORE-DRILLED.
- 18. COORDINATE LOCATIONS AND SIZES OF SERVICE CONNECTIONS WITH THE MECHANICAL DRAWINGS.
- 19. COORDINATE INSTALLATION AND SCHEDULING OF THE INSTALLATION OF UTILITIES WITH ADJACENT CONTRACTORS AND CITY STAFF.
- 20. ALL STREET REPAIRS AND PATCHING SHALL BE PERFORMED PER THE REQUIREMENTS OF THE CITY. ALL PAVEMENT CONNECTIONS SHALL BE SAWCUT. ALL TRAFFIC CONTROLS SHALL BE PROVIDED BY THE CONTRACTOR AND SHALL BE ESTABLISHED PER THE REQUIREMENTS OF THE MINNESOTA MANUAL ON UNIFORM TRAFFIC CONTROL DEVICES (MMUTCD) AND THE CITY. THIS SHALL INCLUDE BUT NOT BE LIMITED TO SIGNAGE, BARRICADES, FLASHERS, AND FLAGGERS AS NEEDED. ALL PUBLIC STREETS SHALL BE OPEN TO TRAFFIC AT ALL TIMES. NO ROAD CLOSURES SHALL BE PERMITTED WITHOUT APPROVAL BY THE CITY.
- 21. ALL STRUCTURES, PUBLIC AND PRIVATE, SHALL BE ADJUSTED TO PROPOSED GRADES WHERE REQUIRED. THE REQUIREMENTS OF ALL OWNERS MUST BE COMPLIED WITH. STRUCTURES BEING RESET TO PAVED AREAS MUST MEET OWNERS REQUIREMENTS FOR TRAFFIC LOADING.
- 22. CONTRACTOR SHALL CORDINATE ALL WORK WITH PRIVATE UTILITY COMPANIES.
- 23. CONTRACTOR SHALL COORDINATE CONNECTION OF IRRIGATION SERVICE TO UTILITIES. COORDINATE THE INSTALLATION OF IRRIGATION SLEEVES NECESSARY AS TO NOT IMPACT INSTALLATION OF UTILITIES.
- 24. CONTRACTOR SHALL MAINTAIN AS-BUILT PLANS THROUGHOUT CONSTRUCTION AND SUBMIT THESE PLANS TO ENGINEER UPON COMPLETION OF WORK.
- 25. ALL JOINTS AND CONNECTIONS IN STORM SEWER SYSTEM SHALL BE GASTIGHT OR WATERTIGHT. APPROVED RESILIENT RUBBER JOINTS MUST BE USED TO MAKE WATERTIGHT CONNECTIONS TO MANHOLES, CATCHBASINS, OR OTHER STRUCTURES.

CITY OF APPLE VALLEY UTILITY NOTES:

- 1. SHOULD EXISTING SANITARY SEWER AND WATER SERVICES NOT BE ABLE TO BE UTILIZED:
- 1.1. EXISTING SERVICE SHALL BE REMOVED BACK TO THE TEE OR EXTENDED FOR USE AS DOMESTIC WATER IF APPLICABLE
- 1.2. NOTIFICATION IS REQUIRED 7 DAYS IN ADVANCE OF LANE OR STREET CLOSURES. 7-DAY ADVANCE WARNING SIGNAGE AND NOTICES TO AFFECTED BUSINESSES FOR THE CLOSURE SHALL BE PROVIDED BY THE CONTRACTOR
- 1.3. A TRAFFIC CONTROL PLAN SHALL BE SUBMITTED AND APPROVED FOR ALL LANE OR STREET CLOSURES BY THE CONTRACTOR. FLAGMEN SHALL BE PROVIDED AS NECESSARY
- 1.4. AN OBSTRUCTION PERMIT SHALL BE APPLIED FOR AND APPROVED WITH DAKOTA COUNTY FOR DETOUR ROUTING PRIOR TO LANE OR STREET
- 1.5. PUBLIC WORKS IS TO BE NOTIFIED PRIOR TO ANY REQUIRED WATER SHUTDOWN AND/OR CONNECTION

UTILITY LEGEND:	U.	TLITY L	EGEND:
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MANHOLE OR CATCH BASIN

MANHOLE OR CATCH BASIN

CATCH BASIN

WATER MAIN

SANITARY SEWER



(651) 454-0002 LOCAL

>>> STORM SEWER

1" = 30'-0" 15'-0" 0 30'-0" 4931 W. 35TH ST. SUITE 200
ST. LOUIS PARK, MN 55416
CivilSiteGroup.com
Matt Pavek Pat Sarver
763-213-3944 952-250-2003

HITNEY DRIVE, APPLE VALLEY, M

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UNDER THE LAWS OF THE STATE OF


Matthew R. Pavek
DATE 04/11/16 LICENSE NO. 44263

REVISION SUMMARY

DATE DESCRIPTION
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UTILITY PLAN

C4.0

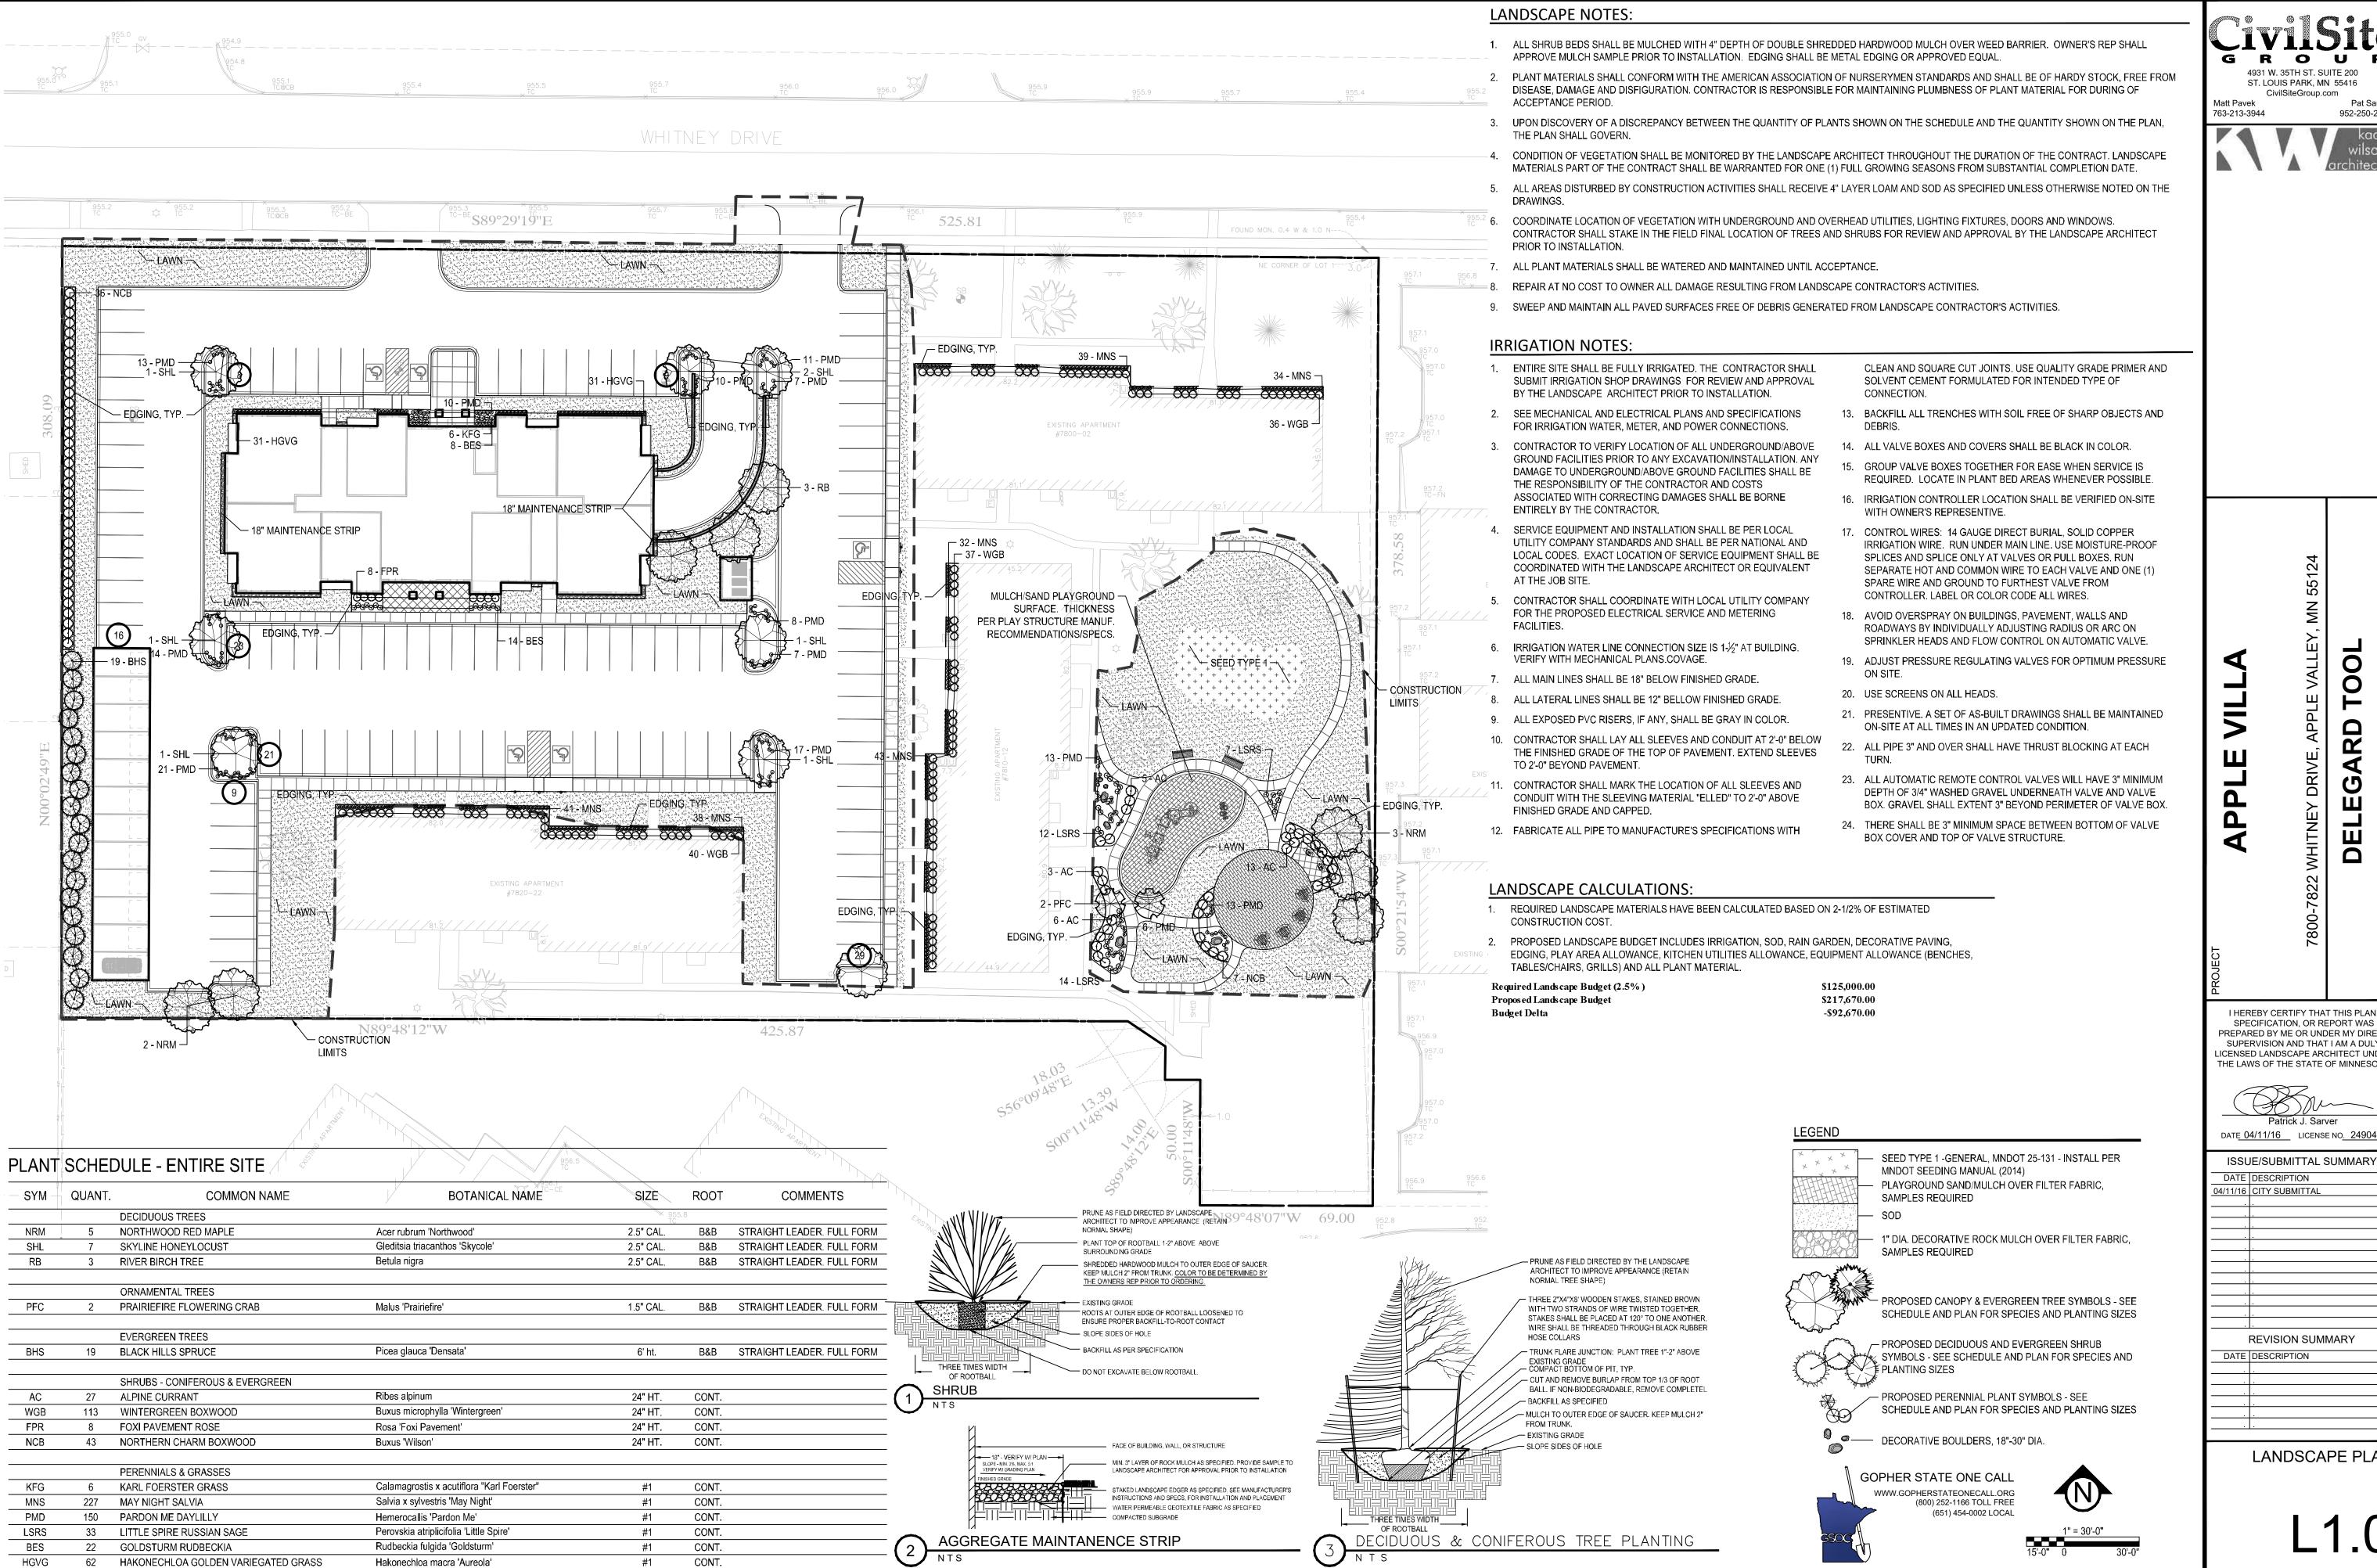

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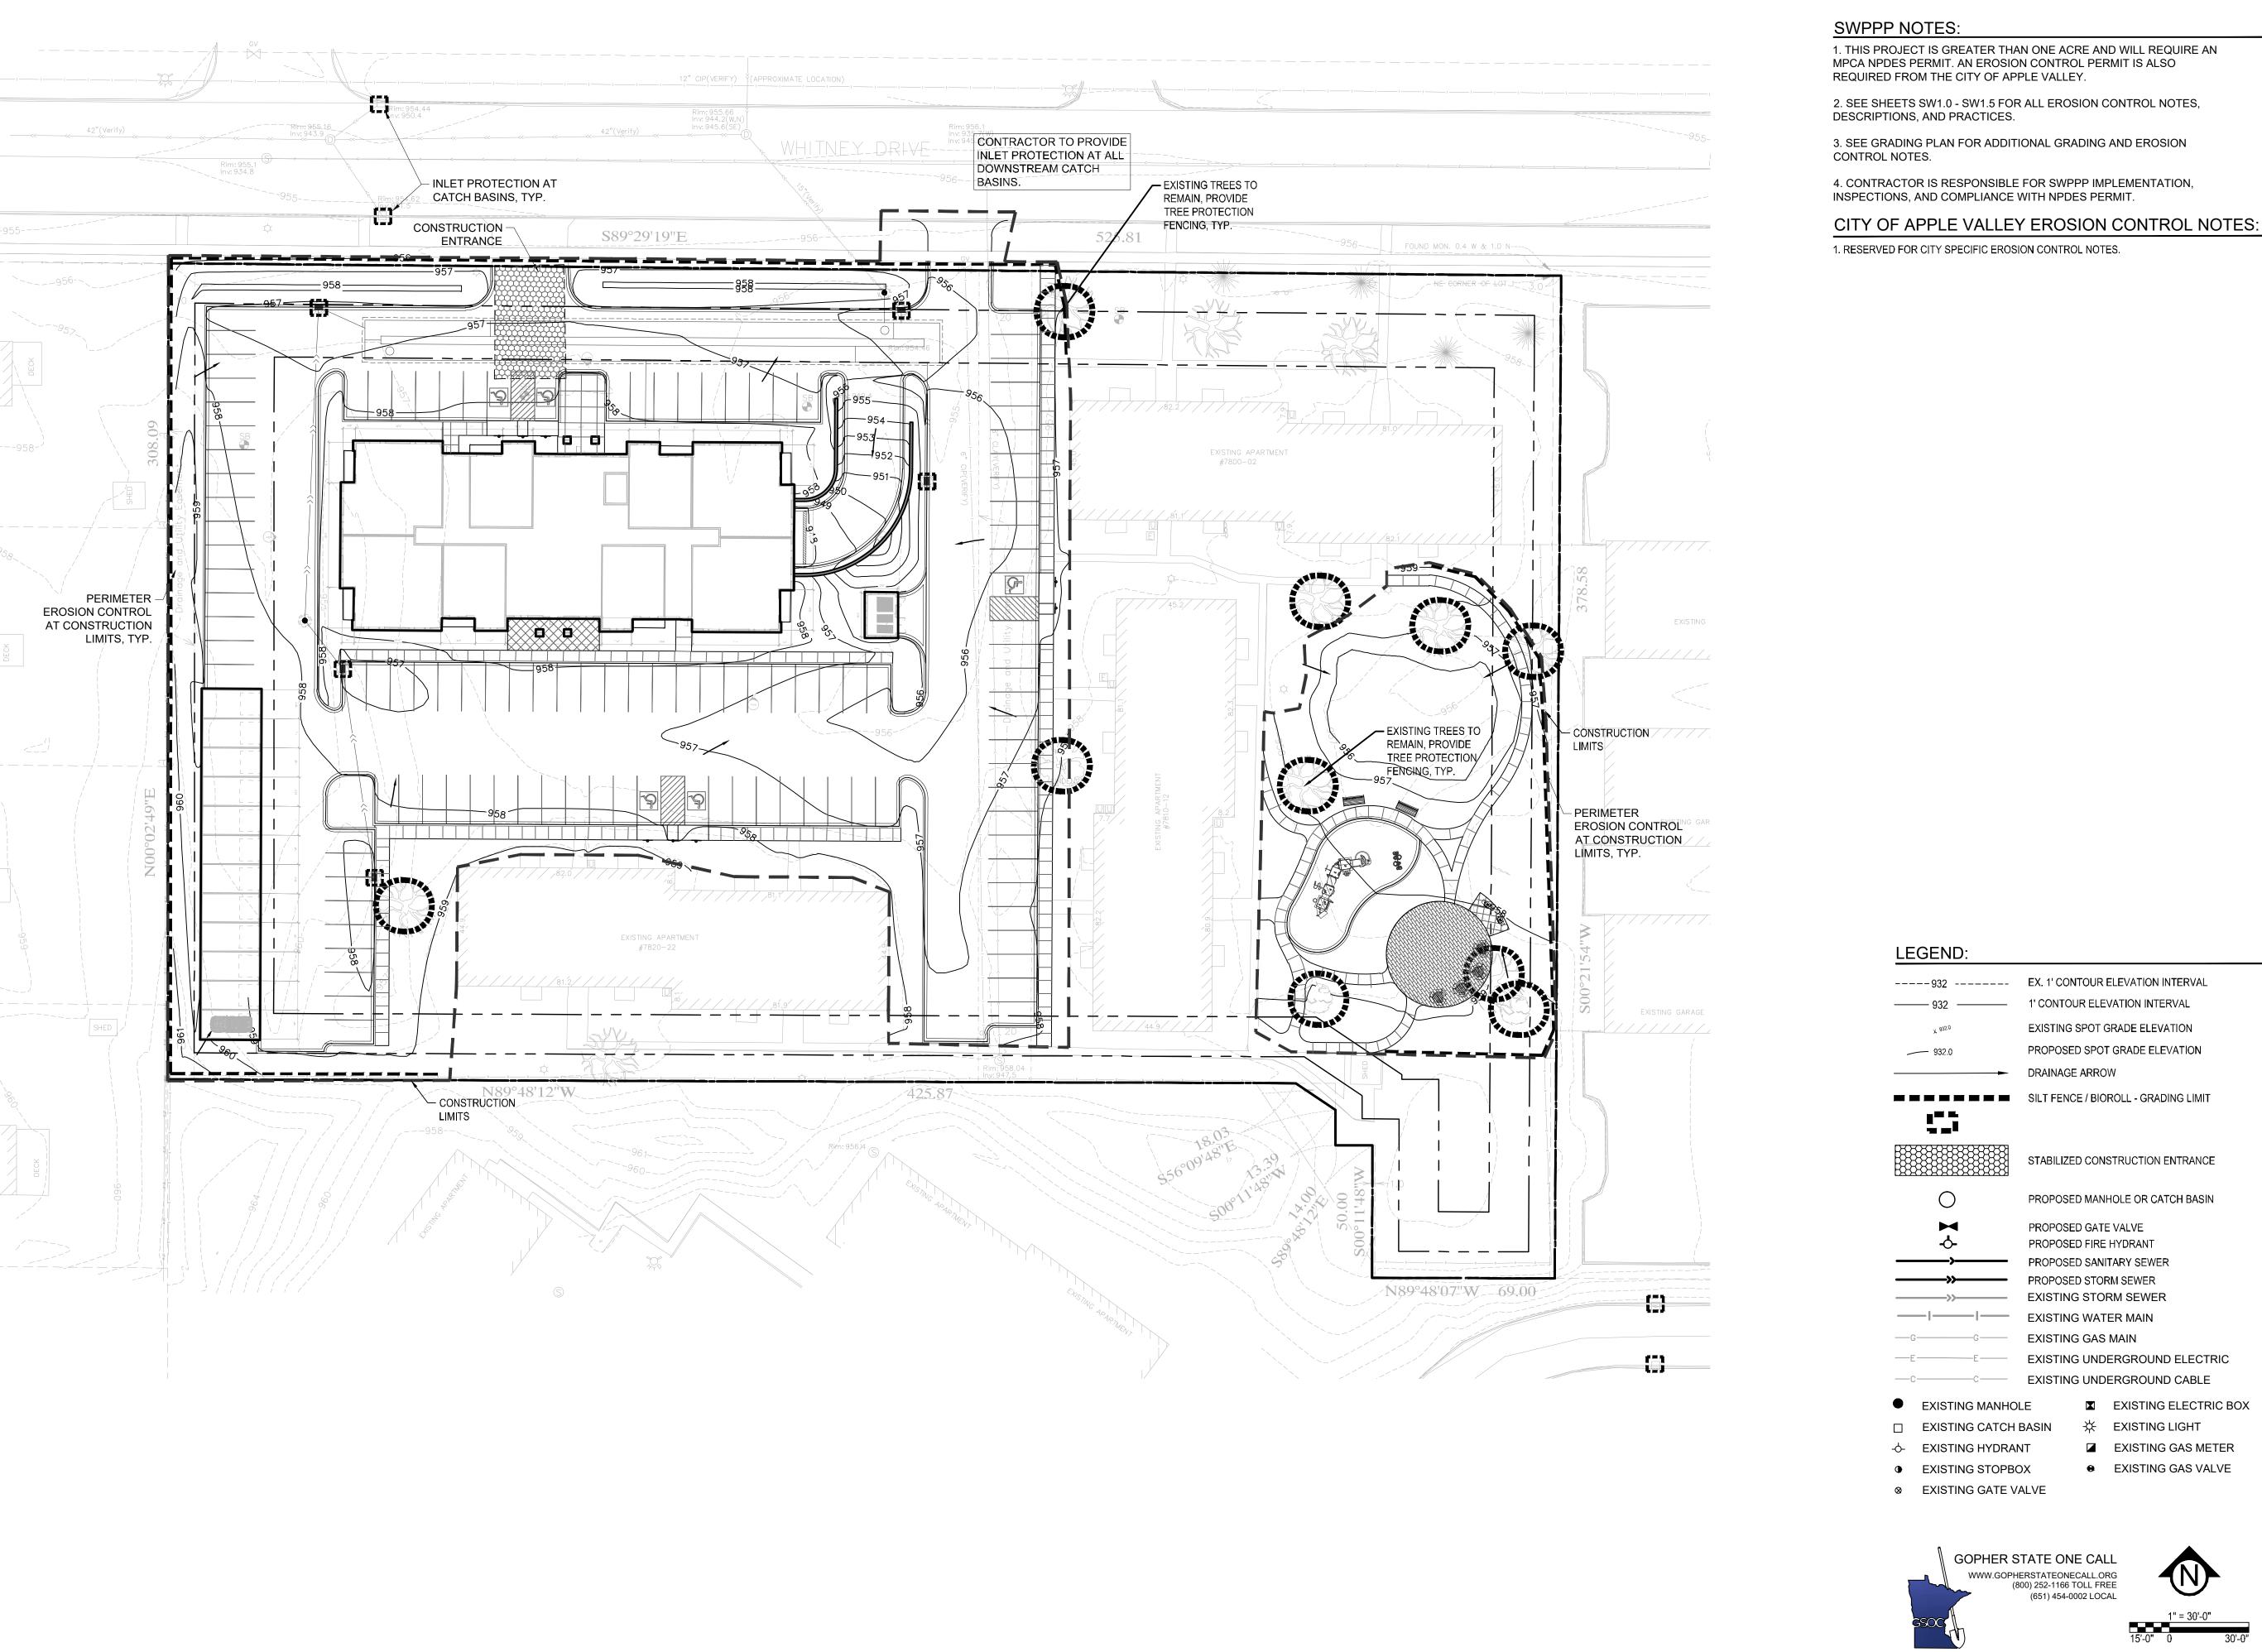
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LANDSCAPE PLAN



RD

GROUP

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952-250-2003

Matt Pavek

763-213-3944

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SWPPP - PROPOSED CONDITIONS

20'-0"

Unit S1


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508 ft²


<u>B Unit S1</u> 552 ft²

1 S1 1/8" = 1'-0"

		4'-8"	
31-8"	B Unit A1 NET 718 ft ² 665 ft ²	27'-0"	
·			'

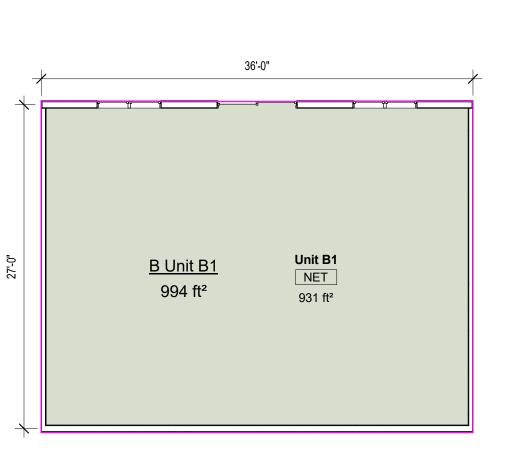

2 B1 1/8" = 1'-0"

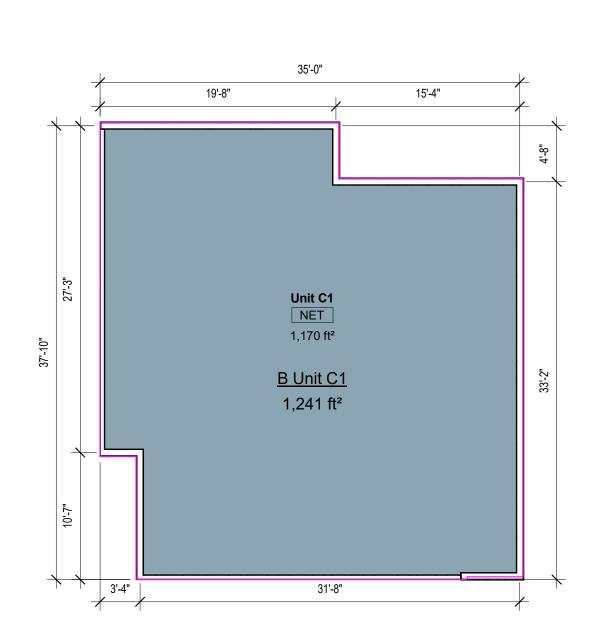

B Unit A1

B Unit B1

B Unit C1

B Unit S1

Grand total: 28

1 + D

2 BR

Unit Counts Total w/ Gross Area

Type Count Area Level

718 ft²

994 ft²

1,241 ft²

552 ft²

3 <u>C1</u> 1/8" = 1'-0"

1301 American Blvd E. Suite 100 Bloomington, MN 55425 tel: (612) 879-6000 fax: (612) 879-6666 www.kaaswilson.com

Civil Site Group 4931 West 35th Street Suite 200 St Louis Park, MN 55416 tel: (763) 213-3944

Apple Villa Apartments 7800 - 7822 Whitney Drive Apple Valley, MN 55124


Delegard Apple Villa Properties LLC 205 E 78th Street Bloomington, MN 55420

Project Number	1614
Date	4/8/2016
Drawn By	Author
Checked By	Checker

Unit Plans

1/8" = 1'-0"



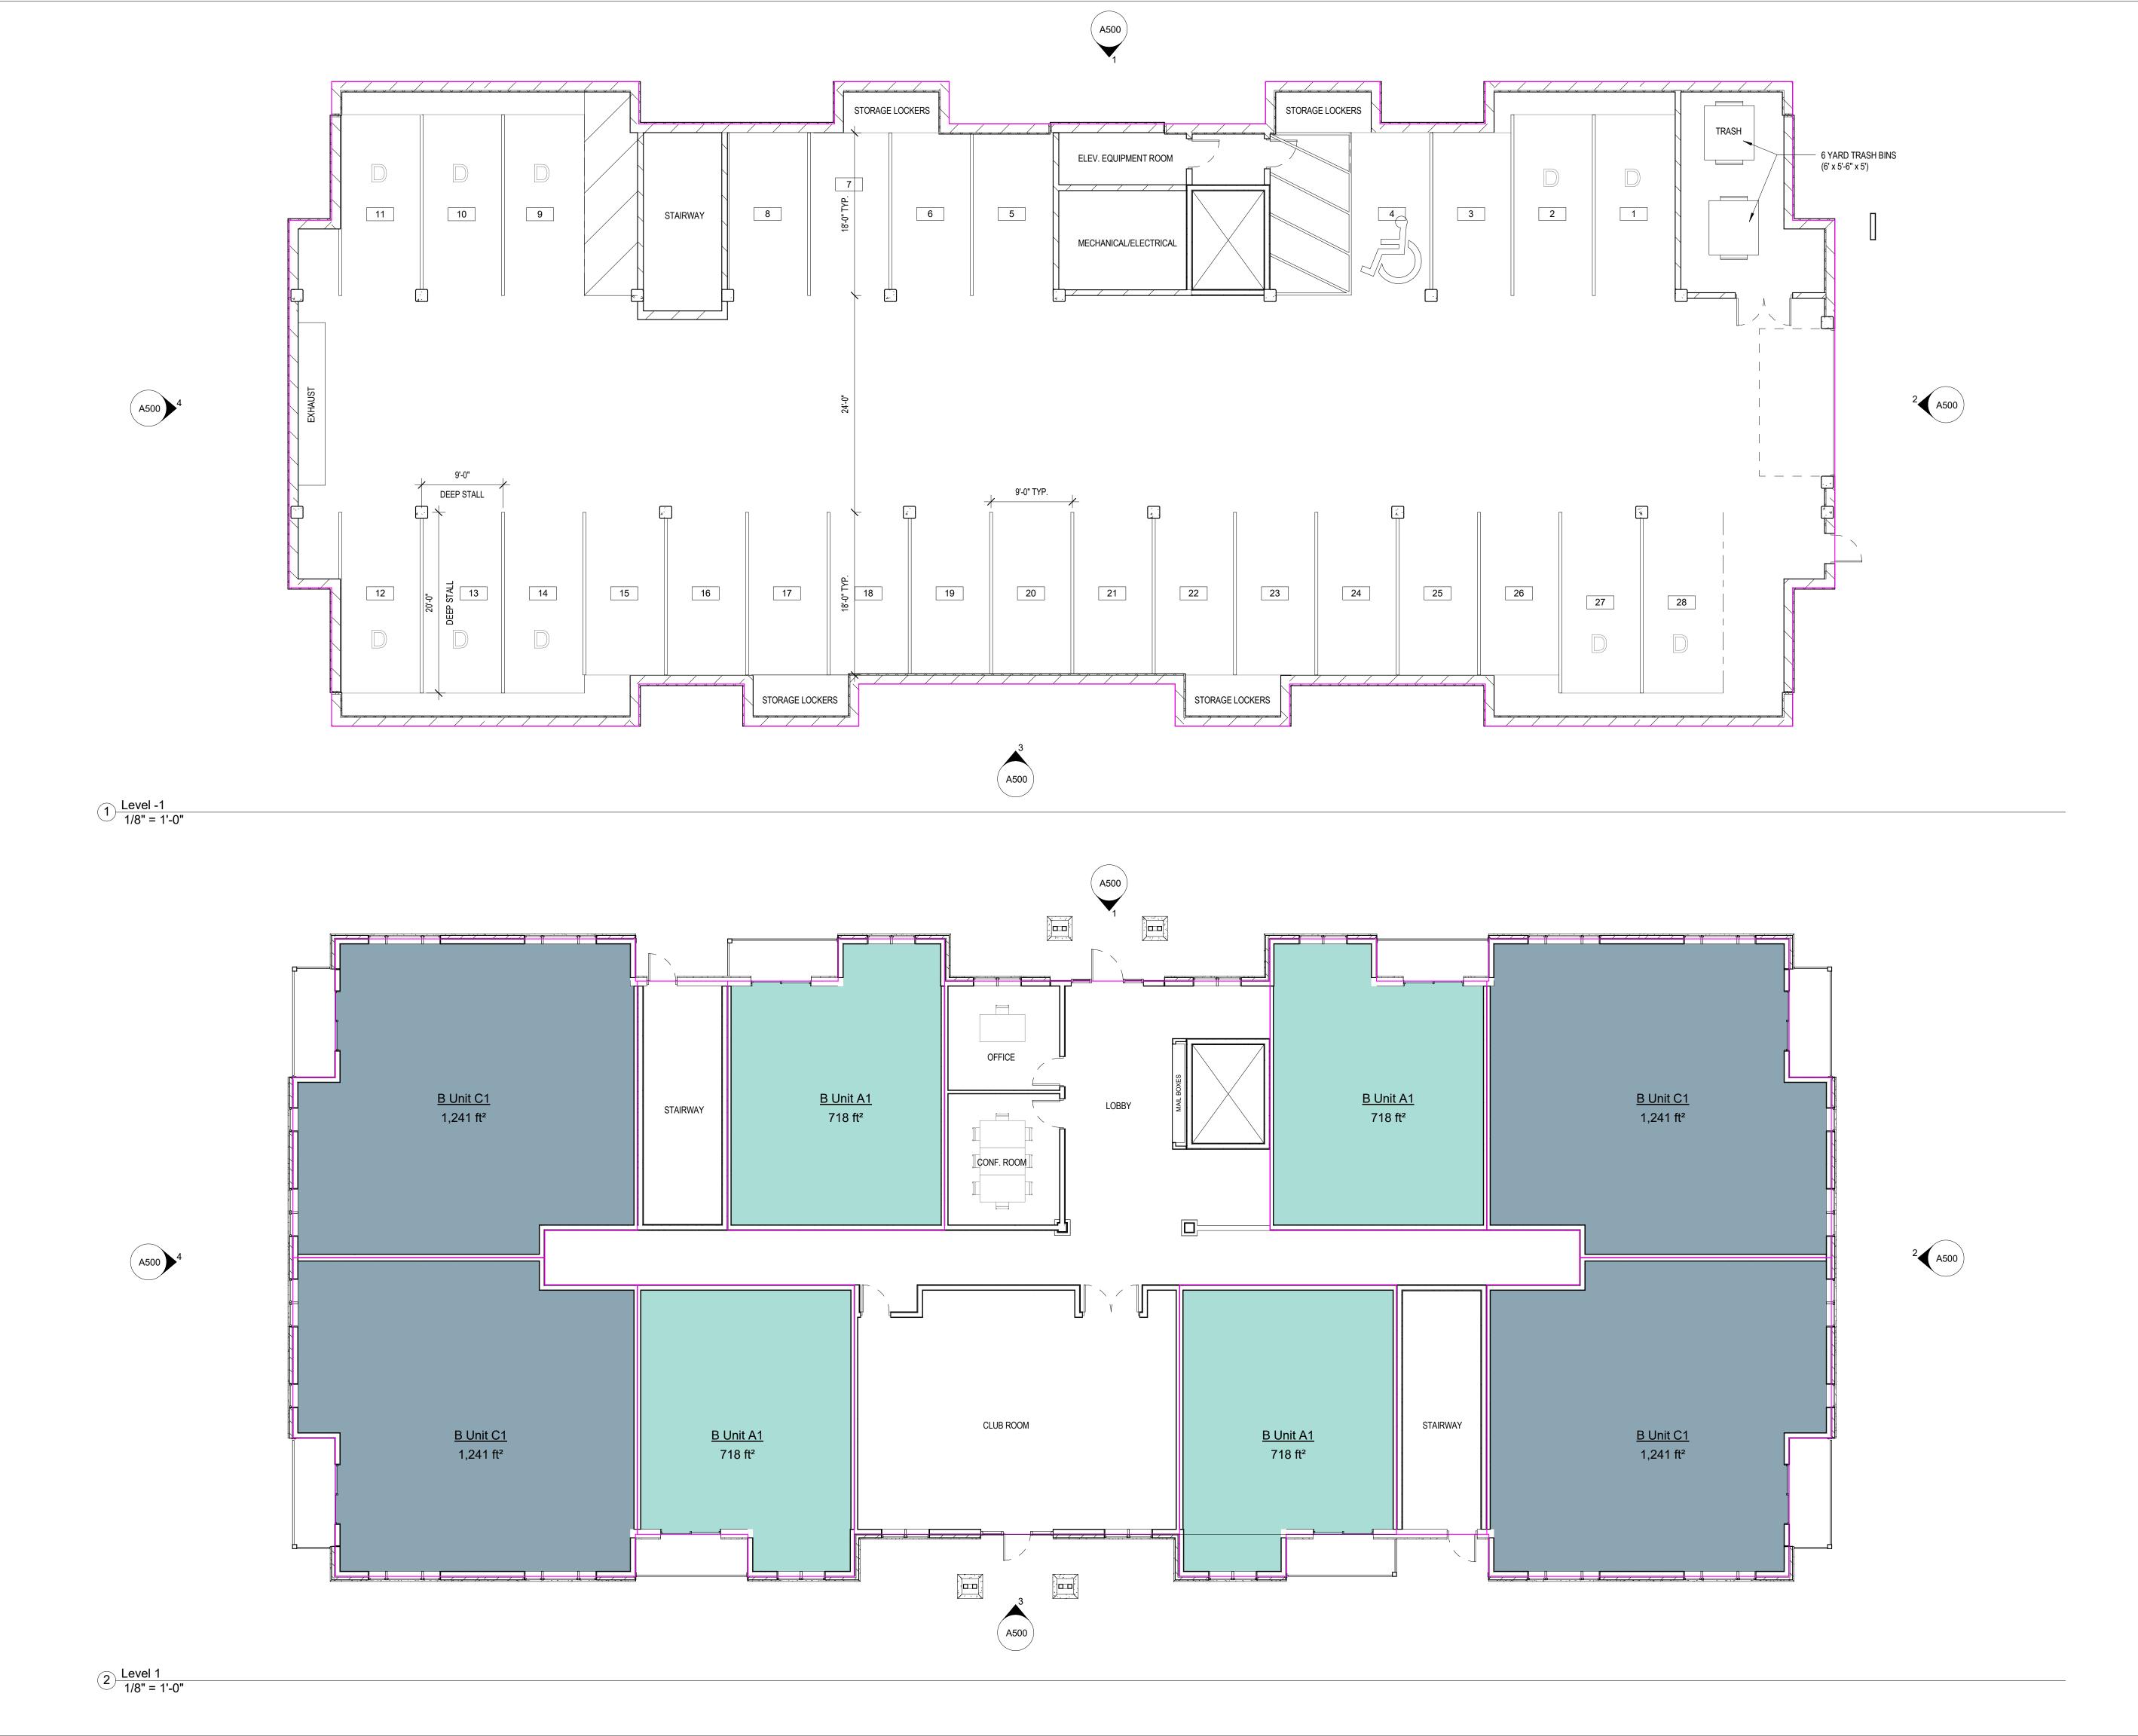



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Apple Villa Apartments 7800 - 7822 Whitney Drive Apple Valley, MN 55124

Delegard Apple Villa Properties LLC 205 E 78th Street Bloomington, MN 55420

Project Number	1614
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Level -1, Level 1

1/8" = 1'-0"
A300



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Apple Villa Apartments 7800 - 7822 Whitney Drive Apple Valley, MN 55124

Delegard Apple Villa Properties LLC
205 E 78th Street
Bloomington, MN 55420

Project Number
Date
Drawn By
Checked By

Level 2, Level 3

1/8" = 1'-0"
A301





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Apple Villa
Apartments
7800 - 7822 Whitney Drive
Apple Valley, MN 55124

Delegard Apple Villa Properties LLC 205 E 78th Street Bloomington, MN 55420

Project Number	1614
Date	4/8/2016
Drawn By	Author
Checked By	Checker

COMSTRUCTION

Date

vision

Exterior Elevations

1/8" = 1'-0"

A500

Civil Site Group 4931 West 35th Street Suite 200 St Louis Park, MN 55416 tel: (763) 213-3944

Apple Villa
Apartments
7800 - 7822 Whitney Drive
Apple Valley, MN 55124

Delegard Apple Villa Properties LLC 205 E 78th Street Bloomington, MN 55420

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Date


evision

. No.

Exterior Elevations

1/8" = 1'-0"

A501

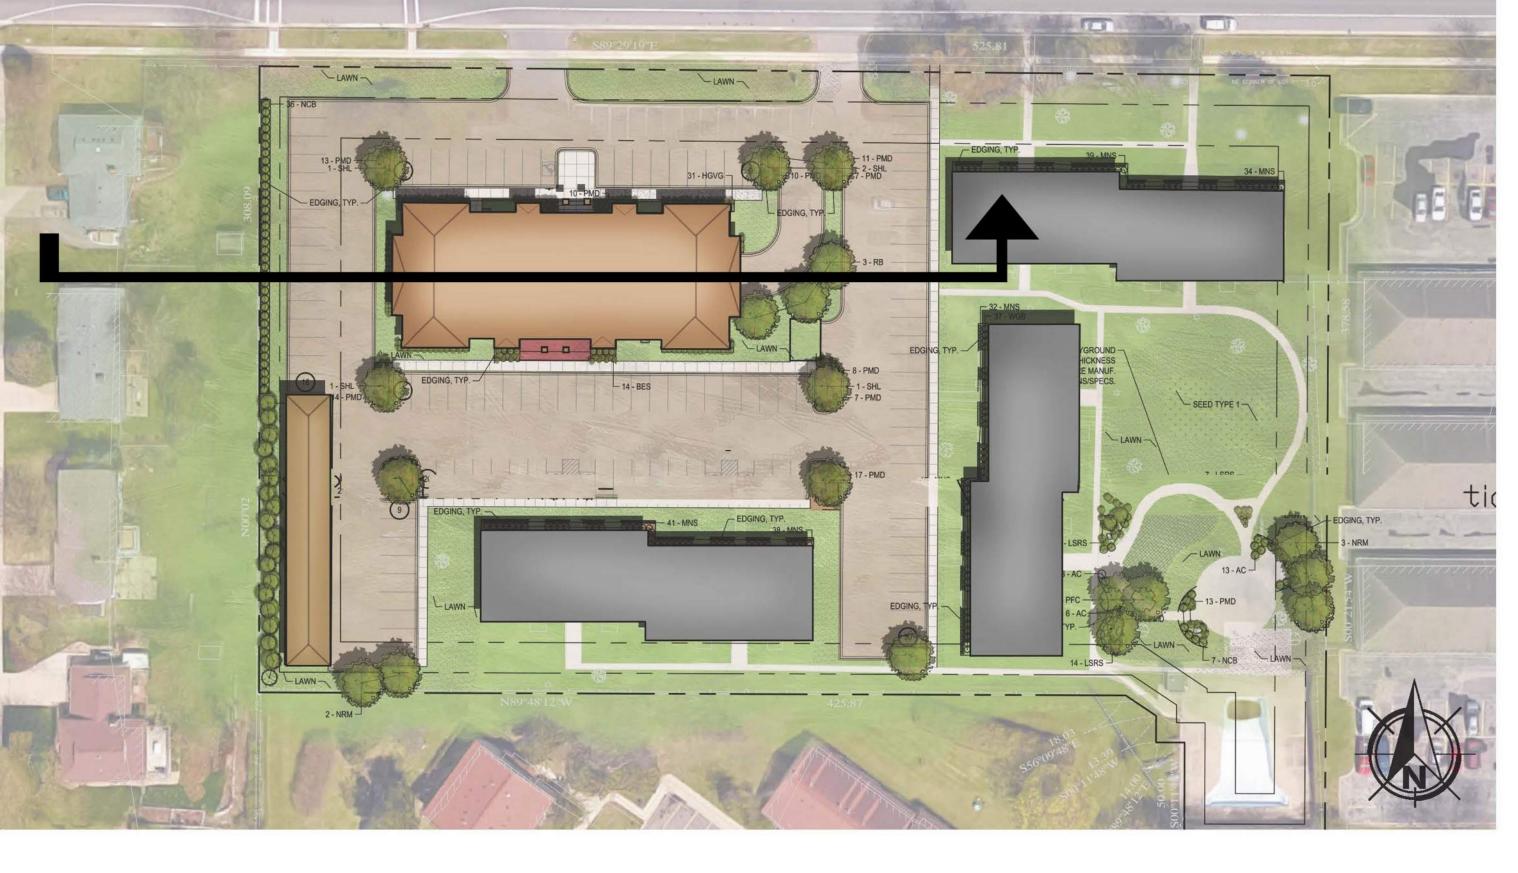

WHITNEY DRIVE



NEWELL DRIVE



1) Site Section 1/16" = 1'-0"



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Apple Villa **Apartments**


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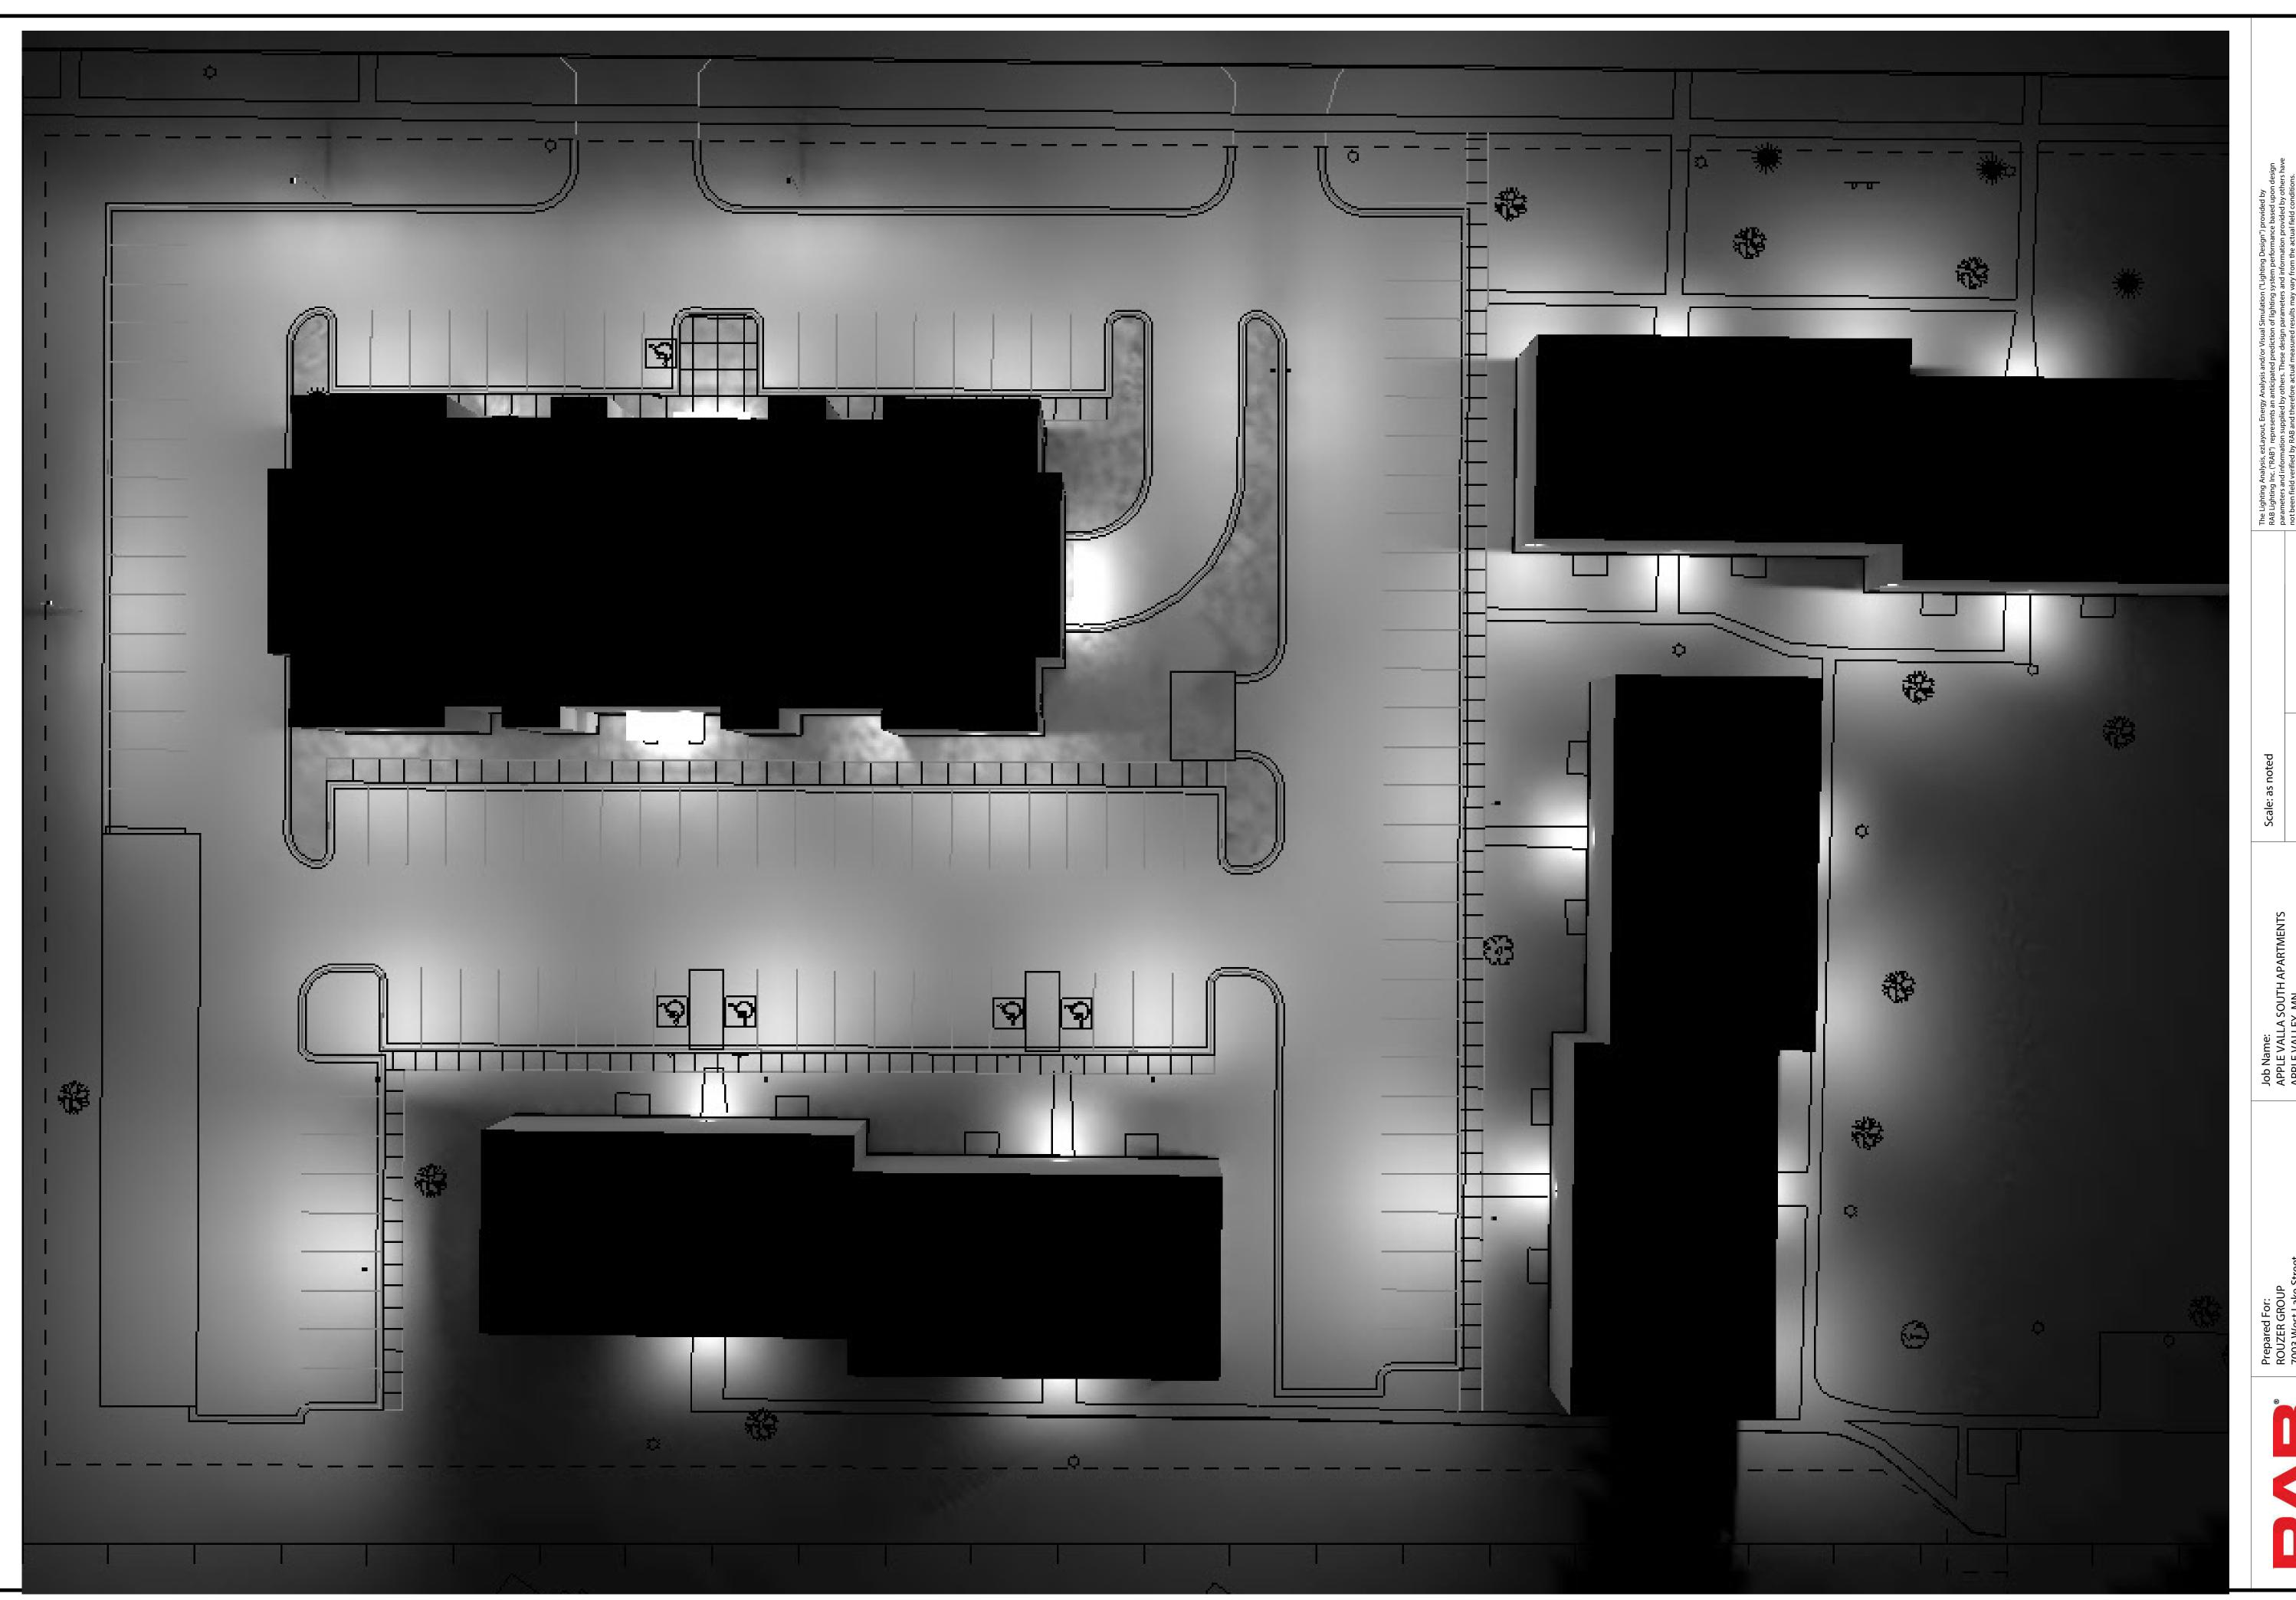
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Building Sections

1/16" = 1'-0"





Job Name: APPLE VALLA SOUTH AF APPLE VALLEY, MN

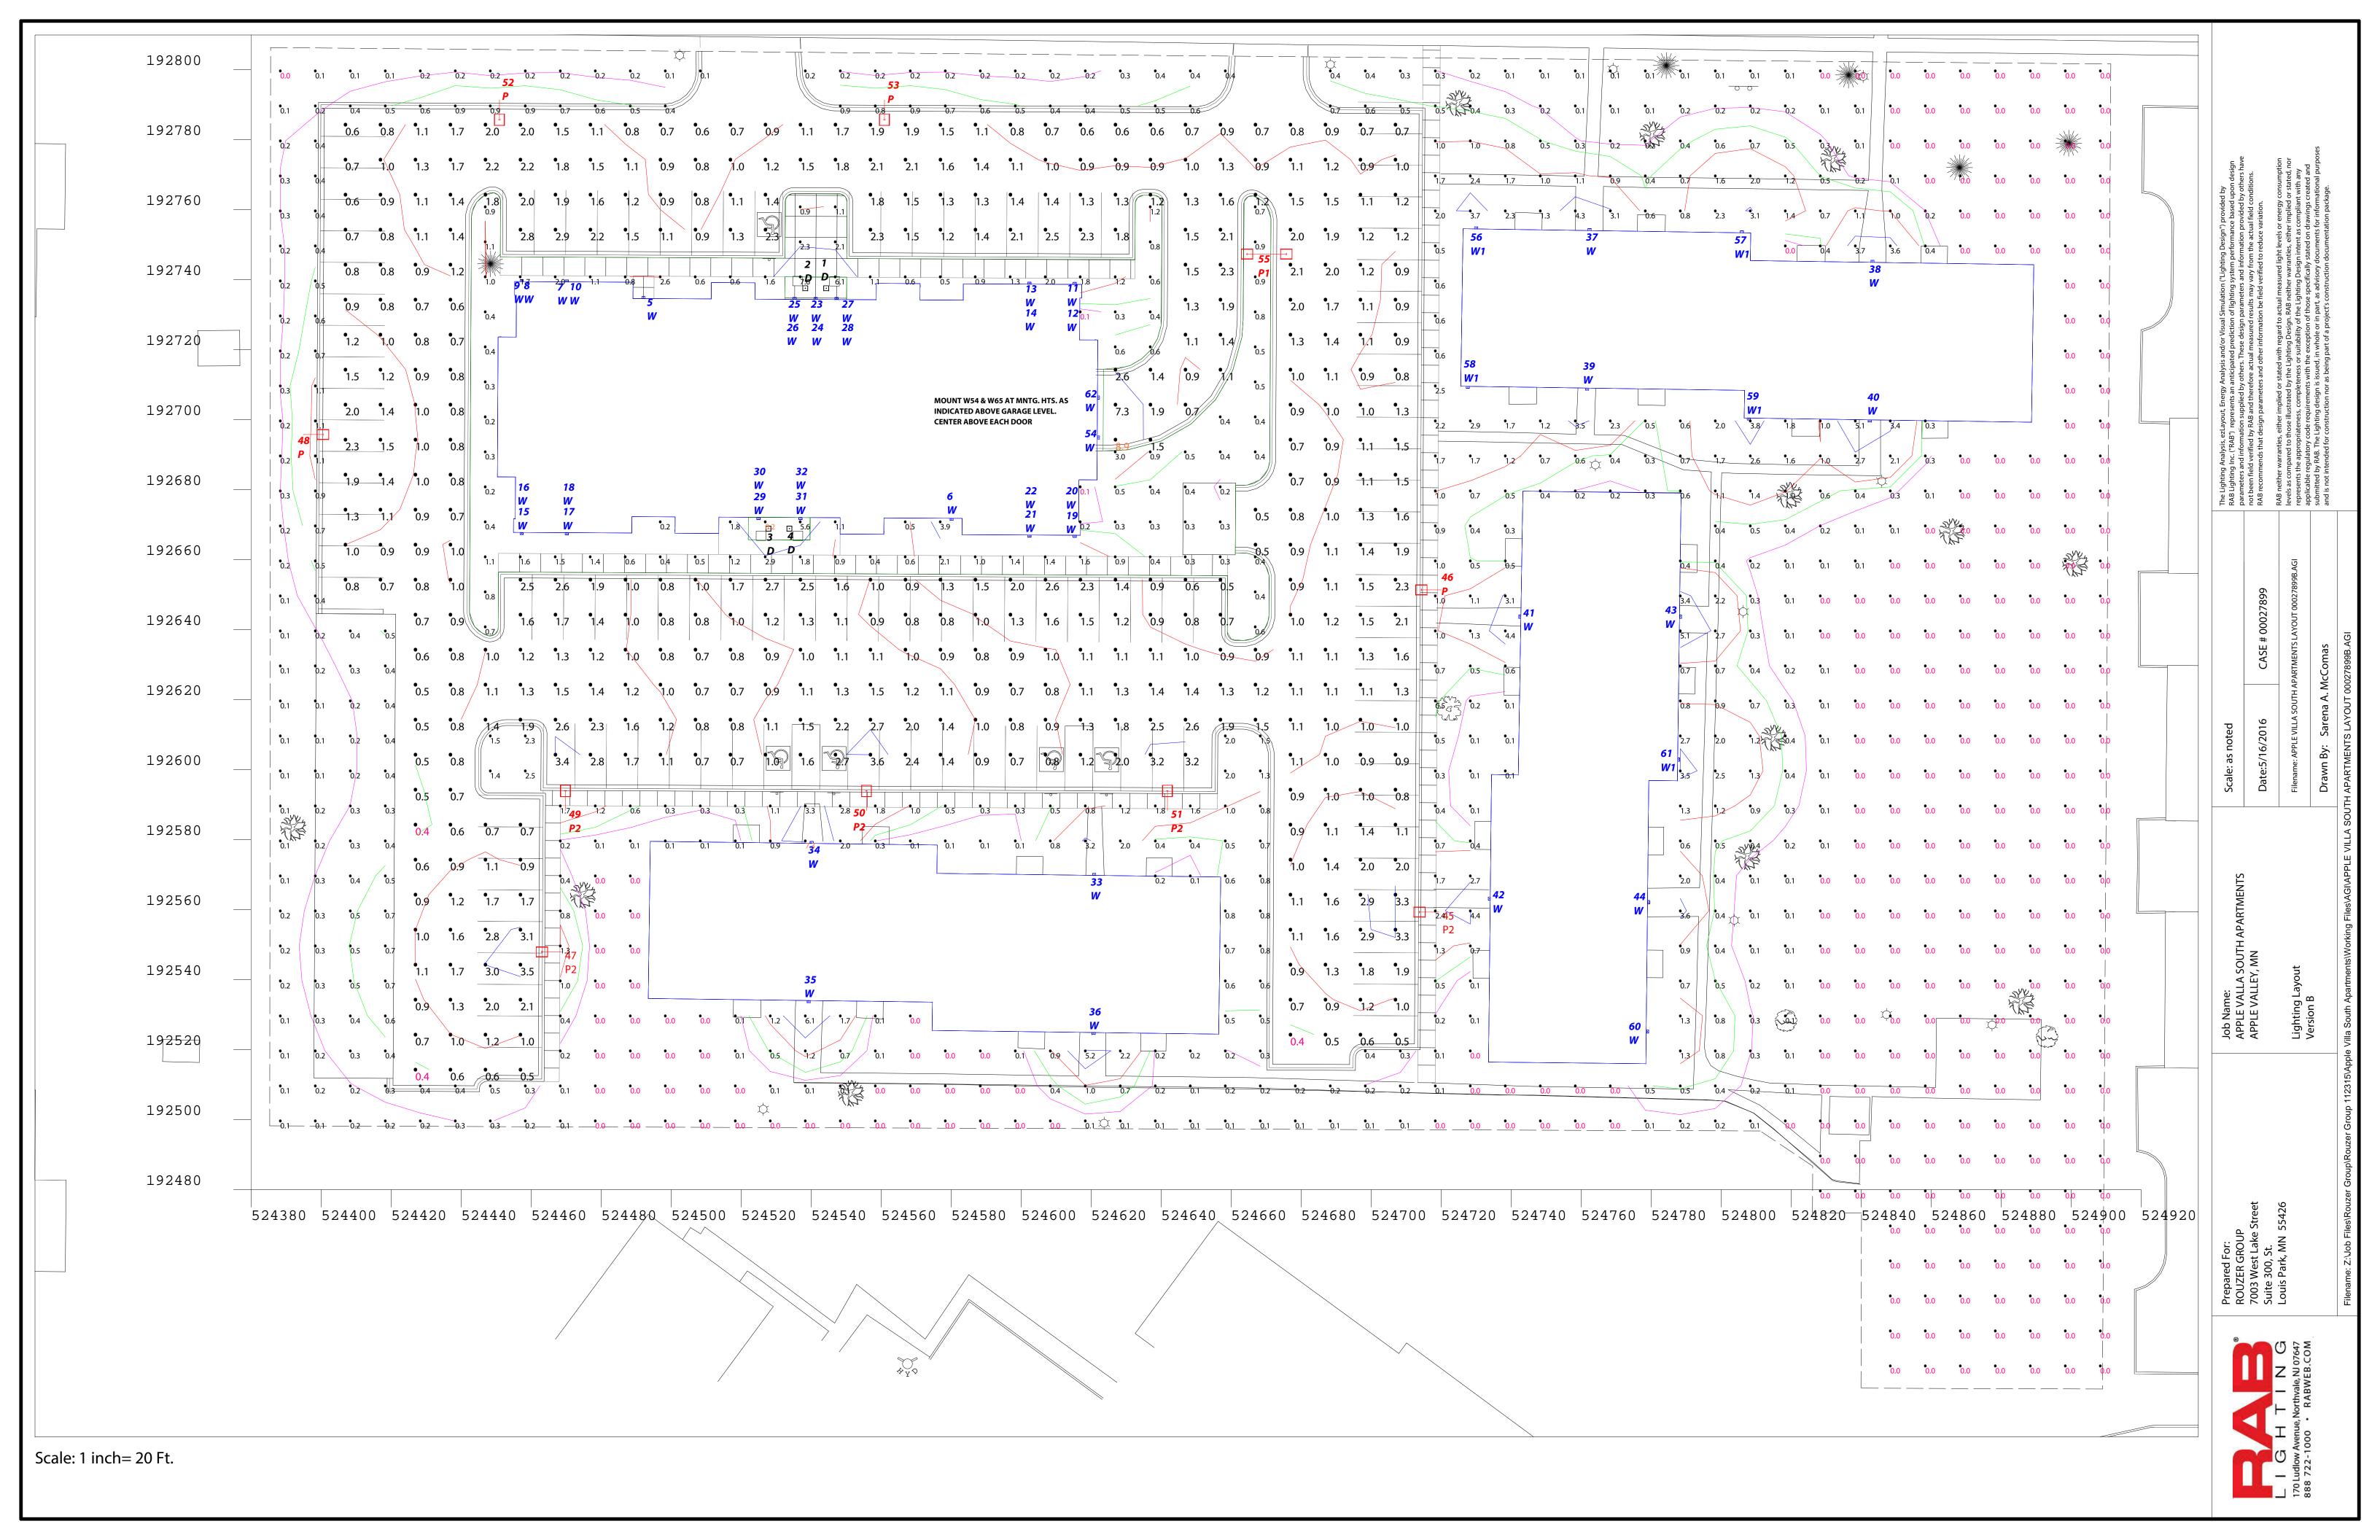

